

City of Fitchburg Planning/Zoning Department 5520 Lacy Road Fitchburg, Wi 53711 (608-270-4200)

SMARTCODE BUILDING/SITE PLAN APPLICATION (ARTICLE 5)

Location of Property: Street Address: Lot 3 - Southwest corner of Lacy Road and Syene Road Legal Description - (Metes & Bounds, or Lot No. And Plants of Plats, on Pages 154-156, as Document Number 5087380, Dane County Rep	at): Lot 3. North Park Eitobhurg
60-030A of Plats, on Pages 154-156, as Document Number 5087380, Dane County Reg Township 06 North, Range 09 East, in the City of Fitchburg, Dane County, Wisconsin, co	istry, located in the NE 1/4 of the NW 1/4 of Section 14 in
Township 06 North, Range 09 East, in the City of Fitchburg. Dane County, Wisconsin, co	ontaining 46,698 square feet, more or less.
2. Description of Project: 71-unit apartment bui	lding with underground parking
3. Existing Transect Zone: 10 Article 3	or Article 4 approval date:
4. Size of Site: 37,077 SF Site Dens	sity (if applicable): 522 sf/du
5. Building/Site Plan applications shall provide plans and	information showing the Sall
 Duilding Disposition 2. Building Configuration 3. Building Use 4. Parking calculation & location 5. Number of dwelling units 6. Base Residential Density 7. Building square footage 8. All requests for Administrative Waivers, if any 9. All requests for Administrative Approvals, if any 10. All known requests for Conditional Use Permits, if any 11. Civic Building design(s) 	12. Landscape Standards 13. Signage Standards 14. Special Requirements, if any 15. Architectural Standards 16. Fencing Standards 17. Lighting Standards 18. Statistics, maps and other documentation showing how the Article 5 application, in combination with the past approved Article 5 plans, will meet the approved Community Regulating Plan, and the standards of this Chapter.
***Also submit all mapping in either CADD or GIS files	
Current Owner(s) of Property: Goldleaf Fitchburg	LLC
Address: 2379 University Ave.	Phone No.: 608-233-4423
Contact Person: WING FIIKOUSKI	10 Name
Address: 7266 Cty Hwy V V, Sun Prairie, WI 535	E-mail: mfilkouski@littlecreekconst.com
Respectfully Submitted By: Mulliple Owner's or Authorized Agent's Si *(If multiple owners, application shall include sta	Date: 1/14/2015
PLEASE NOTE – Applicants shall be responsible for legal or City. It is the responsibility of the owner/applicant to insurequirements.	
*Application shall be accompanied by one (1) PDF document of plans, two (2) reduced sets of plans (11" x 17"), and the requir	
FOR CITY USE ONLY	
Date Received: 142015 Permit Request No.:	
	2/24/2015 with
	affached conditions.

Lot 3 North Park Article 5 Conditions:

- 1.) No other permit or approval is waived or deemed satisfied except for the approval provided herein.
- 2.) Approval is based on plan set with site plan dated February 5, 2015, accompanying materials and responses to staff comments, along with ADR & Administrative Approvals/Waivers granted by the Plan Commission on 2/17/2015.
- 3.) All signage shall follow the requirements of Chapter 23 and obtain proper approvals for all signage.

SITE PLAN REVIEW CHECKLIST:

YES	<u>NO</u>	
X		Signed and completed Building / Site Plan – Article 5 Application
X		Proposals / design compliant with Ch. 23 SmartCode District
X		Vicinity map (no larger than 11 x 17)
X		2 (two) reduced size (11 x 17) plan sets
X	110	1 (one) full set of bounded drawings, include landscape plans
X		1 (one) electronic copy (.tif or .pdf) of the plan set
X	100	CADD or GIS files for all mapping
		Plans to include existing and proposed information on the following:
X		Location of structures, improvements and landscaping
X	100	North arrow and scale bar
X		Site boundaries
X	100	Setback distance from property lines
X		Rights-of-way, property lines and easements
X		Location & dimensions of driveways, streets and sidewalks
X		On-site parking and circulation
n/a		Location of loading spaces, if applicable
X		Location of trash receptacle enclosure
X		Location of all outdoor electrical, plumbing and mechanical equipment
X		Landscaping Plan for site
TBD		Signage Plan for site (type & fixtures)
X		Elevations for each side of the building detailing the materials & colors
X		Fencing Plan (if installing fence)
X		Lighting Plan (in footcandles) & fixtures cut-sheets
X		Site plan data table containing: transect zone, site size in square feet or
		acres, lot coverage by building in square feet and percentage, residential density in units per acre (if applicable), square feet of impervious surface and parking and landscaping calculations.

ARTICLE 5 SUPPLEMENTAL FORM: Revised 1/30/15 **Building Disposition:** _____ North Park Lot(s) 3 Transect Zone: T5 Lot Width 169'-0" Lot Coverage 82.1% Type of Building: Edgeyard Sideyard Rearyard Courtyard Specialized Principal Building Setbacks: Front (principal) 12' Front (secondary) 12' Side 12' Rear 26' Frontage buildout (if applicable): 86.7 Primary Setback: 12' feet Outbuilding: Yes ■ No Outbuilding Setbacks: Front n/a Side n/a Rear n/a **Building Configuration:** Type of Private Frontage: Common Yard Porch & Fence ☐ Light court ☐ Forecourt ■ Stoop ☐ Shopfront ☐ Gallery ☐ Arcade ☐ Parking Lot ☐ Common Entry & Planter % of clear glass of 1st story Façade: 30.3Overall building height: 46' feet 1st story: _____ feet 2nd story: 10'-8" feet 3[X] story: 10'-8" feet 4th story: 10'-8" **Building Use:** Use of principal building: Multi-family residential # of residential dwelling units in principal building (if applicable): 71dwelling units Use of accessory building: *If multiple uses in building, please provide square footage of each type of use. Parking & Density: # of parking stalls provided within the Lot: $^{34~{\rm site}/60~{\rm garage}}$ # of parking stalls along parking lane corresponding to the Lot Frontage: 0# of parking stalls by lease or purchase from a Civic Parking Reserve within the Community Unit: $^{ m O}$ If looking to use Effective Parking standards, applicant shall provide completed Parking Occupancy Rate Table (Table 20) Current density for transect zone within the block: 66 units/acre

(per 5.9.2f)

Parking Location:
Drive width: 20'-24'
Material of parking / drive areas: Asphalt
Landscape:
% of landscape area of 1 st Layer of Principal Frontage: 50 (minimum 30%)
% of landscape area of 1 st Layer of Secondary Frontage: 55 (minimum 30%)
of trees planted within the 1 st Layer: 4
Requirements: T3 – 1 tree shall be planted within the 1 st Layer for every 800 sq. ft of landscape area
T4 – minimum of 1 Understory Tree or 6 shrubs planted within 1 st Layer for every 500 sq. ft. of 1 st Layer landscape area.
T5 – Trees not required in 1 st Layer.
Signage:
A or B grid street:
Type of sign:(* note: A sign permit is required for all signs)
Architectural: For buildings other than single-family and two-family Edgeyard & Sideyard Residential:
Type of building materials: brick veneer, vinyl siding, composite panels, aluminum railings, precast sills/bands *Vinyl siding is not permitted.
Fence: ■ Yes □ No
If yes, fence at the 1 st Layer shall be painted or stained.
Balcony or porch: Yes No
Fencing:
Height of fence (if applicable): 3'-6" feet
<u>Lighting:</u> Are all parking lot and exterior building lighting on private lots dark sky approved or full cut-off fixtures? ■ Yes □ No.
Average lighting levels, in footcandles, at the building frontage line: 0



City of Fitchburg Planning/Zoning Department 5520 Lacy Road Fitchburg, WI 53711 (608-270-4200)

SMARTCODE APPROVAL ADMINISTRATIVE WAIVER APPLICATION

Location of Property: Street Address: Lot 3 - Southwest corner of Lacy Road a	and Svene Pood
Legal Description - (Metes & Bounds, or Lot No. And Plat):	Lot 3 North Park Fitchhurs as recorded in Volume
60-030A of Plats. on Pages 154-156, as Document Number 5087380. Dani 1/4 of Section 14, in Township 06 North, Range 09 East, in the City of Fitchbur	e County Registry Togated in the NE 1/4 of the NIM
Administrative Waiver Details:	
 Administrative Waiver Application shall be subr Application, a Regulating Plan Application or Site/Buildin 	ng Plan Application. gs and statistical data that the applicant wishes to
Administrative Waiver Checklist:	
 Describe each specific Waiver requested, in 23 SmartCode District, clearly noting what we the difference. Describe why each Waiver is requested. With 3. Describe any mitigation strategies to offset the second secon	vas required by the Code, what is proposed and hy can the current regulations not be met?
The preceding information is considered to be the minimuzoning Administrator may require additional information for	um information for submission, and the or review.
Current Owner(s) of Property: Goldleaf Fitchburg LLC	
Address: 2379 University Ave.	Phone No.: 608-233-4423
Contact Person: Mike Filkouski	E-mail: mfilkouski@littlecreekconst.c
Address: 7266 Cty Hwy V V, Sun Praine, Wt 53590	Phone No.: 608-628-1116
Respectfully Submitted By: Mahal A Clark Owner's or Authorized Agent's Si *(If multiple owners, application shall include sta	gnature atement of consent by all property owners)
PLEASE NOTE – Applicants shall be responsible for legal or City. It is the responsibility of the owner/applicant to instruction requirements.	outside consultant costs incurred by the ure compliance with all local and state
FOR OUTVIEST ONLY	
FOR CITY USE ONLY	
Date Received: 2/5/2015	
Comments:	
APPROVED by Plan Commission	
as part of 2/17/2015	
ADR approval.	

January 28, 2015

Mr. Tom Hovel
City Planner
Department of Planning and Development
City of Fitchburg
5520 Lacy Road
Fitchburg WI 53711

Re: Administrative Waiver Lacy Rd. and Syene Rd. – Lot 3

KBA Project # 1332

Dear Mr. Hovel,

This is a request for an Administrative Waiver to allow a 71-unit apartment building to be classified as an edge yard building in the development located at the southwest corner of Lacy Road and Syene Road. Due to the corner lot configuration of the site it is impossible to designate this building as a rear yard building as there is a 2 - 12 foot setback required on the secondary frontage side of the building.

Thank you for your time reviewing our proposal.

Sincerely,

J. Randy Bruce Managing Member





City of Fitchburg Planning/Zoning Department 5520 Lacy Road Fitchburg, WI 53711 (608-270-4200)

SMARTCODE ADMINISTRATIVE WAIVER **APPLICATION**

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L		VI	1 10	DCIL	

Street Address: Lot 3 - Southwest corner of Lacy Road and Syene Road

Legal Description - (Metes & Bounds, or Lot No. And Plat): Lot 3, North Park Fitchburg, as recorded in Volume

60-030A of Plats, on Pages 154-156, as Document Number 5087380, Dane County Registry, located in the NE 1/4 of the NW 1/4 of Section 14, in Township 06 North, Range 09 East, in the City of Fitchburg, Dane County, Wisconsin, containing 46,698 square feet, more or less.

Administrative Waiver Details:

- Administrative Waiver Application shall be submitted concurrent with a SmartCode Rezoning Application, a Regulating Plan Application or Site/Building Plan Application.
- All documentation including maps text drawings and statistical data that the applicant wishes to

by Plan Commission as part of 2/17/2015

app approval

be considered in support of their Waiver(s) should be submi	
Administrative Waiver Checklist:	
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Owner's or Authorized Agent's Signa *(If multiple owners, application shall include states) PLEASE NOTE — Applicants shall be responsible for legal or or City. It is the responsibility of the owner/applicant to insure requirements.	ment of consent by all property owners) utside consultant costs incurred by the
FOR CITY USE ONLY	
Date Received: 26/2015	
Comments: APPROVED	

January 12, 2015

Mr. Tom Hovel
City Planner
Department of Planning and Development
City of Fitchburg
5520 Lacy Road
Fitchburg WI 53711

Re: Administrative Waiver Lacy Rd. and 5yene Rd. – Lot 3

KBA Project # 1332

Dear Mr. Hovel,

This is a request for an Administrative Waiver to allow up to a 44" recess behind the primary setback line on a 71-unit apartment building in the development located at the southwest corner of Lacy Road and Syene Road.

Ordinance No. 2014-O-20, which created Article 5.6.2 f vii, states that the Plan Commission may grant Administrative Approval for a maximum 44" recess behind the primary setback of a multifamily unit. The other conditions of this Article have been met with the current plans. The additional recesses are needed to allow for the placement of HVAC grills on the side wall of the recessed balconies.

Lacy Road elevation: 146'-10'' total length -39'-0'' recesses greater than 18'' = 107'-10'' (73.4%) North Park elevation: 191'-10'' total length -52'-2'' recesses greater than 18'' = 139'-8'' (72.8%)

Thank you for your time reviewing our proposal.

Sincerely,

J. Randy Bruce Managing Member



to



FOR CITY USE ONLY

City of Fitchburg Planning/Zoning Department 5520 Lacy Road Fitchburg, WI 53711 (608-270-4200)

SMARTCODE APPROVAL ADMINISTRATIVE WAIVER APPLICATION

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Administrative Waiver Details:	
Administrative Waiver Application shall be submitte Application, a Regulating Plan Application or Site/Building Plan All documentation, including maps, text, drawings a be considered in support of their Waiver(s) should be submit	an Application. Ind statistical data that the applicant wishes
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Address: 2379 University Ave.	Phone No.: 608-233-4423
Contact Person: Mike Filkouski	E-mail: mfilkouski@littlecreekconst.c
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Respectfully Submitted By: Mahal Affilian Owner's or Authorized Agent's Signal *(If multiple owners, application shall include statem	
PLEASE NOTE – Applicants shall be responsible for legal or out City. It is the responsibility of the owner/applicant to insure requirements.	tside consultant costs incurred by the compliance with all local and state

Date Received: 2/5/2015

Comments:

APPROVED

by Plan Commission

as part of 2/12/2015

ADR approva!

January 12, 2015

Mr. Tom Hovel
City Planner
Department of Planning and Development
City of Fitchburg
5520 Lacy Road
Fitchburg WI 53711

Re: Administrative Waiver Lacy Rd. and Syene Rd. – Lot 3

KBA Project # 1332

Dear Mr. Hovel,

This is a request for an Administrative Waiver to allow the use of vinyl siding on the façade of a 71-unit apartment building in the development located at the southwest corner of Lacy Road and Syene Road.

Ordinance No. 2014-O-13, which amends Article 5.13.4c and 5.13.5b relative to vinyl siding states that the Plan Commission may grant Administrative Approval for the use of vinyl siding. The characteristics of vinyl siding, including its durability and low maintenance requirements, will ensure that this building will maintain its appearance well into the future. The other conditions of this Ordinance have been met with the current plans.

Thank you for your time reviewing our proposal.

Sincerely,

J. Randy Bruce Managing Member





City of Fitchburg Planning/Zoning Department 5520 Lacy Road Fitchburg, WI 53711 (608-270-4200)

as part of 2/17/2015 ADR approval

SMARTCODE ADMINISTRATIVE WAIVER APPLICATION

Location of Property:
Street Address: Lot 3 - Southwest corner of Lacy Road and Syene Road
Legal Description - (Metes & Bounds, or Lot No. And Plat): Lot 3, North Park Fitchburg, as recorded in Volume
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Administrative Waiver Application shall be submitted concurrent with a SmartCode Rezoning
Application, a Regulating Plan Application or Site/Building Plan Application. 2. All documentation, including maps, text, drawings, and statistical data that the applicant wishes to
 All documentation, including maps, text, drawings and statistical data that the applicant wishes to be considered in support of their Waiver(s) should be submitted with this application.
Administrative Waiver Checklist:
 Describe each specific Waiver requested, including citation of the provision from Chapter 23 SmartCode District, clearly noting what was required by the Code, what is proposed and the difference.
2. Describe why each Waiver is requested. Why can the current regulations not be met?
 Describe any mitigation strategies to offset the effect of the relief requested.
The preceding information is considered to be the minimum information for submission, and the Zoning Administrator may require additional information for review.
Current Owner(s) of Property: Goldleaf Fitchburg LLC
Address: 2379 University Ave. Phone No.: 608-233-4423
Contact Person: Mike Filkouski E-mail: mfilkouski@littlecreekconst.c
Address: 7266 Cty Hwy V V, Sun Praine, WI 53590 Phone No.: 608-628-1116
Respectfully Submitted By: Michael At ellerch Date: 1/14/2015
Owner's or Authorized Agent's Signature *(If multiple owners, application shall include statement of consent by all property owners)
PLEASE NOTE – Applicants shall be responsible for legal or outside consultant costs incurred by the City. It is the responsibility of the owner/applicant to insure compliance with all local and state requirements.
FOR CITY USE ONLY
Date Received: 2/5/2015
Comments:
APPROVED BY Plan Commission

January 12, 2015

Mr. Tom Hovel
City Planner
Department of Planning and Development
City of Fitchburg
5520 Lacy Road
Fitchburg WI 53711

Re: Administrative Waiver Lacy Rd. and Syene Rd. – Lot 3

KBA Project # 1332

Dear Mr. Hovel,

This is a request for an Administrative Waiver to allow the use of a hedge streetscreen for the non-parking areas on a 71-unit apartment building in the development located at the southwest corner of Lacy Road and Syene Road. The owner would like to pursue Section 5.7.5 (f) with the intent of adding interest with plantings instead of standard fencing materials.

Street screening at parking areas will remain per Smartcode requirements as shown on the submitted drawings.

Thank you for your time reviewing our proposal.


Sincerely,


J. Randy Bruce Managing Member







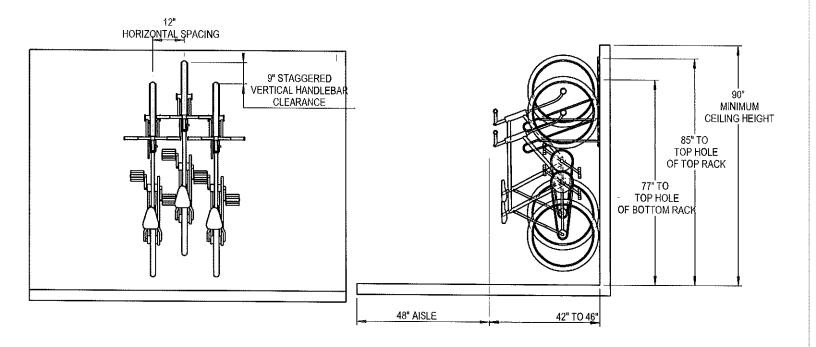

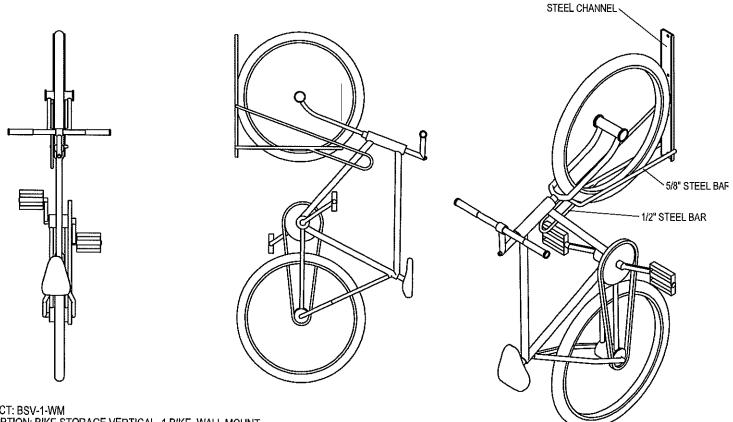

PRODUCT: BSV-1-WM DESCRIPTION: BIKE STORAGE VERTICAL, 1 BIKE, WALL MOUNT

DATE: 8-7-09 ENG: BLW


CONFIDENTIAL DRAWING AND INFORMATION IS NOT TO BE COPIED OR DISCLOSED TO OTHERS WITHOUT THE CONSENT OF TRILARY, INC. SPECIFICATIONS ARE SUBJECT TO CHANGE WITHOUT NOTICE.


92007 TRILARY, INC. ALL PROPRIETARY RIGHTS RESERVED.

NOTES:


- INSTALL BIKE RACKS ACCORDING TO MANUFACTURER'S SPECIFICATIONS.
 CONSULTANT TO SELECT COLOR(FINISH), SEE MANUFACTURER'S SPECIFICATION
 SEE SITE PLAN FOR LOCATION OR CONSULT OWNER.




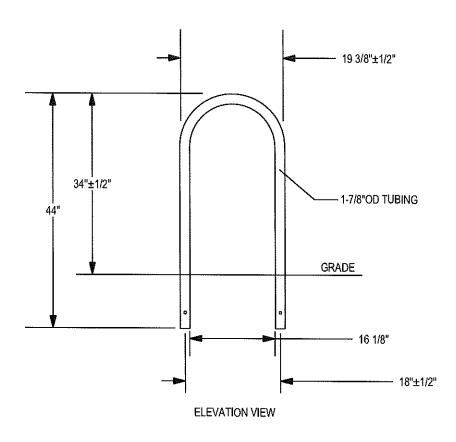


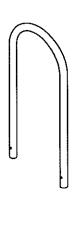



CHECK DESIRED MOUNT ID

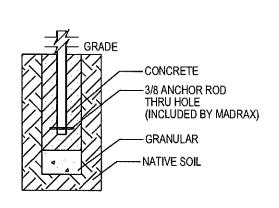

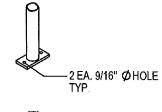

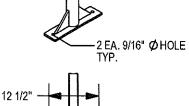

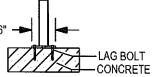

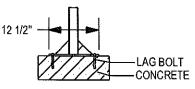

☐ IN GROUND MOUNT (IG)

□ SURFACE FLANGE MOUNT (SF) SECTION VIEWS

☐ SURFACE GUSSET MOUNT (SG) **UPCHARGE**

PRODUCT: U190-IG(SF,SG) DESCRIPTION: 'U' BIKE RACK

2 BIKE, SURFACE OR IN GROUND MOUNT

DATE: 8-5-02 ENG: TLG

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NOTES:

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 CONSULTANT TO SELECT COLOR(FINISH), SEE MANUFACTURER'S SPECIFICATIONS.
 SEE SITE PLAN FOR LOCATION OR CONSULT OWNER.



Monogram 46

Vinyl Siding

General Description: MonogramTM provides the look of wood siding, but does not require the upkeep common to wood. Monogram siding is manufactured with TrueTextureTM rough cedar finish molded directly from real cedar boards. Available in a selection of profiles, Monogram offers the industry's widest selection of colors. It is appropriate for use in new construction for single family homes, multi-housing projects and light commercial developments. Monogram is also an ideal product for remodeling.

Styles:

Profile	Finish	Panel Projection (Nominal)	Wall Thickness (Nominal)	Lock Design	Colors	Accessory Pocket
Double 4" Clapboard	Rough Cedar	3/4"	.046"	CertiLock TM post-formed positive lock	41	3/4''
Double 5" Clapboard	Rough Cedar	3/4"	.046"	CertiLock TM post-formed positive lock	19	3/4"
Double 5" Dutchlap	Rough Cedar	3/4"	.046"	CertiLock TM post-formed positive lock	27	3/4"

Colors: Monogram siding profiles are available in the industry's widest selection of colors. All colors are Spectrophotometer controlled and utilize exclusive PermaColorTM color science.

Arbor Blend**	Cypress	Heritage Cream	Pacific Blue*	Sterling Gray
Arctic Blend**	Desert Tan	Herringbone	Sable Brown*	Suede
Autumn Red*	Flagstone*	Ivy Green*	Sandpiper	Terra Cotta*
Autumn Yellow	Forest*	Light Maple	Sandstone Beige	Timber Blend**
Bermuda Blue	Frontier Blend**	Linen	Savannah Wicker	Weathered Blend**
Buckskin	Glacier Blend*	Meadow Blend*	Scagrass	
Canyon Blend*	Granite Gray	Mountain Cedar*	Silver Ash	
Charcoal Gray*	Green Tea	Natural Clay	Snow	
Colonial White	Hearthstone*	Oxford Blue	Spruce*	

^{*} Deluxe Color: Deluxe colors utilize CertainTeed's proprietary manufacturing process to provide the unique appearance of semi-transparent and solid stained wood siding.

STUDfinderTM: The patented STUDfinder Installation System combines precisely engineered nail slot locations with graphics. Nail slots are positioned 16" on center to allow for alignment with studs. STUDfinder graphics centered at each slot provide a quick and easy guide to help locate studs.

RigidFormTM: Monogram RigidForm 220 technology has a stiff, double-thick .092" nail hem for a straighter-on-the-wall appearance and wind load performance.

Lock: Uniquely designed for ease of installation, Monogram features the CertiLockTM locking system; a post-formed positive lock which provides for self-aligning installation. Properly installed panels will snap together with an audible "click" signaling that they are ready for nailing.

Accessories: CertainTeed manufactures a wide range of siding accessories which are compatible with Monogram siding styles and colors. Accessory products include installation components, soffit, window and door trim, corner lineals, corner systems and decorative moldings.

^{**} Premium Color: Made with an exclusive, highly durable polymer capstock combined with unique heat distortion modifiers that helps ensure long-term weatherability in darker hues that would otherwise quickly fail.

Composition: Monogram siding products are produced using CertaVin™ custom-formulated PVC resin. This resin is produced exclusively by CertainTeed, allowing CertainTeed to maintain the high quality of its siding products.

Technical Data: Monogram siding is in compliance with ASTM specification for Rigid Polyvinyl Chloride (PVC) Siding Insulated Vinyl Siding D 3679, and the requirements of section R703.11 of the International Residential Code, and section 1405.14 and 2603 of the International Building Code. Monogram siding meets or exceeds the properties noted in Table 1.

ASTM E 84	Meets Class 1 flame spread requirements as tested according to ASTM E84.
ASTM D 1929	Self-ignition temperature 813°F
ASTM D 635	Material is self-extinguishing with no measurable extent of burn when tested in accordance with this specification.
NFPA 268	Radiant Heat Test - Ignition Resistance of Exterior Walls - Conclusion that CertainTeed met the conditions for
	allowable use as specified in section 1406 of the International Building Code.

Important Fire Safety Information: When rigid vinyl siding is exposed to significant heat or flame, the vinyl will soften, sag, melt or burn, and may thereby expose material underneath. Care must be exercised when selecting underlayment materials because many underlayment materials are made from organic materials that are combustible. You should ascertain the fire properties of underlayment materials prior to installation. All materials should be installed in accordance with local, state and federal Building Code and fire regulations.

Wind Load Testing: CertainTeed Monogram double 4" siding has been tested per ASTM D 5206 standard test method for resistance to negative wind load pressures of 63 psf, which equates to more than 220 mph per VSI windspeed calculation guidelines, when installed with nails positioned 16" on center. Check with your local building inspector for wind load requirements in your area on the type of structure you are building.

Documents: CertainTeed Vinyl Siding meets the requirements of one or more of the following specifications.

Texas Department of Insurance Product Evaluation EC-11

Conforms to ASTM Specification D3679

Florida BCIS Approval FL1573

ICC-ES Evaluation Report ESR-1066

CCMC #13008-L

For specific product evaluation/approval information, call 800-233-8990.

Installation: Prior to commencing work, verify governing dimensions of building, examine, clean and repair, if necessary, any adjoining work on which the siding is in any way dependent for its proper installation. Sheathing materials must have an acceptable working surface. Siding, soffit and accessories shall be installed in accordance with the latest editions of CertainTeed installation manuals on siding and soffit. Installation manuals are available from CertainTeed and its distributors.

Warranty: CertainTeed supports Monogram siding products with a Lifetime Limited Warranty including PermaColor Lifetime Fade Protection to the original homeowner. The warranty is transferable if the home is sold.


Technical Services: CertainTeed maintains an Architectural Services staff to assist building professionals with questions regarding CertainTeed siding products. Call 800-233-8990 for samples and answers to technical or installation questions.


Sample Short Form Specification: Siding as shown on drawings or specified herein shall be Monogram Vinyl Siding as manufactured by CertainTeed Corporation, Valley Forge, PA. The siding shall have a .092" thick nail hem. Installation shall be in accordance with manufacturer's instructions.

Three-part Format Specifications: Long form specifications in three-part format are available from CertainTeed by calling our Architectural Services Staff at 800-233-8990. These specifications are also available on our website at <u>certainteed.com</u>.



CertainTeed Corporation P.O. Box 860 Valley Forge, PA 19482 certainteed.com © 12/13

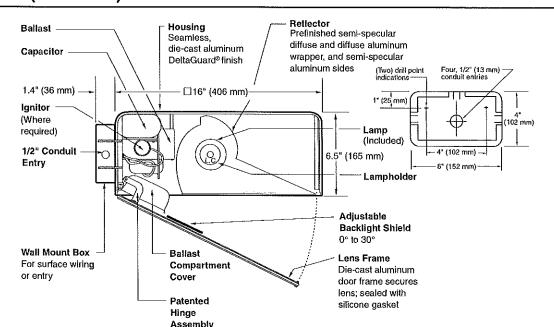

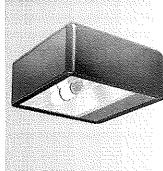

Notes

SPEC#	WATTAGE	CATALOG #
P	ULSE START META	AL HALIDE
SPEC#	150W PSMH	ACW615-(a)(b)
SPEC#	200W PSMH	ACW620-(a)(b)
SPEC#	250W PSMH	ACW625-(a)(b)
SPEC#	320W PSMH	ACW632-(a)(b)
SPEC#	350W PSMH	ACW635-(a)(b)
SPEC#	400W PSMH	ACW640-(a)(b)
	HIGH PRESSURE S	DDIUM
SPEC#	250W HPS	ACW525-(a)(b)
SPEC#	400W HPS	ACW540-(a)(b)

Specify (a) Voltage & (b) Options. Reduced envelope ED28 lamp.

	(a) VOLTAGE SUFFIX KEY
M	120/208/240/277V (Standard)
T	120/277/347V (Canada Only) (Standard)
1	120V
2	277V
27	277V Reactor (PSMH Only)
3	208V
4	240V
5	480V
6	347V (Canada Only)

For voltage availability outside the US and Canada, see Bulletin TD-9 or contact your Ruud Lighting authorized International Distributor

	(b) OPTIONS (factory-installed)
-(a)F	Fusing
-(a)P	Button Photocell
-5P	External Photocell (for 480V)
Q	Quartz Standby (includes 100W quartz lamp) (N/A on 277V Reactor)

Specify (a) Single Voltage — See Voltage Suffix Key

GENERAL DESCRIPTION

60° forward throw sharp cutoff luminaire with adjustable backlight control for HID lamp, totally enclosed. Backlight shield provides precise cutoff adjustability from 0° (nadir) to 30° (house-side). Housing is seamless, die-cast aluminum. Fixture mounts to wall with a 4" (102 mm) x 6" (152 mm) x 1.4" (36 mm) cast aluminum mounting box and gasket. Two 5/16" threaded mounting studs are supplied with nuts and sealing washers to attach fixture to mounting box. Also provided are four threaded and closed 1/2" conduit entries. Lens assembly consists of rigid aluminum frame and high-impact, clear-tempered glass, and backlight shield.

ELECTRICAL

Fixture includes clear, mogul-base lamp; 320 - 400W PSMH utilize the ED28 reduced envelope lamp. Pulse-rated porcelain enclosed, 4kv-rated screw-shell-type lampholder with spring-loaded center contact and lamp grips, 150° C temperature supply wire required. Lamp ignitor included. All ballast assemblies are high-power factor and use the following circuit type:

277V Reactor 150 - 400W PSMH

HX— High Reactance 150W PSMH

CWA — Constant Wattage Autotransformer 200 - 400W PSMH; 250 - 400W HPS

PATENTS

US 4,689,729; 4,709,312

LABELS

ANSI lamp wattage label supplied, visible during relamping. UL Listed in US and Canada for wet locations and enclosure classified IP65 per IEC 529 and IEC 598.

FINISH

Exclusive Colorfast DeltaGuard® finish features an E-coat epoxy primer with medium bronze ultra-durable powder topcoat, providing excellent resistance to corrosion, ultraviolet degradation and abrasion. The finish is covered by our seven-year limited warranty.

ACCESSORIES

Wire Guard FWG-16


RUUD LIGHTING

16" (406 mm) AREA CUTOFF LIGHT


EPA RATING

Isofootcandle plots show initial footcandles at grade. (Footcandles ÷ 0.0929 = Lux)


EPA 0.93 for single fixture with 0° tilt (Consult factory for EPA rating on multiple units).

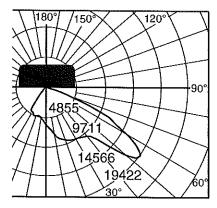


Candlepower distribution curve ot 400W PSMH Area Cutoff Light without backlight shield.

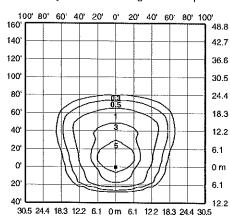


Isotootcandle plot of 400W PSMH Area Cutoft Light at 30' (9.1 m) mounting hetght, 0° verlical tilt, wilh backlight shield removed. (Plan view)

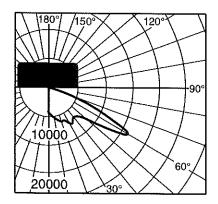

Lighting Sciences Inc. Certitied Test Report No. LSI 10246 Candlepower distribution curve ot 250W HPS Area Cutotf Floodlight without backlight shield.

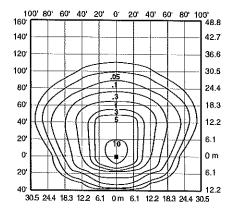

Isotootcandle plot of 400W HPS Area Cutoff Floodlight at 25' (7.6 m) mounting height, 0° vertical tilt, with backlight shield removed. (Plan view)

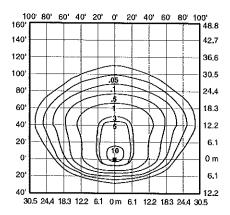

Isotootcandle plot of 400W HPS Area Cutott Floodlight at 25' (7.6 m) mounting height, 0° vertical tilt, with backlight shield located for backlight cutott. (Plan view)






Up/Down Cutoff & Deep Shielded


E5 Series Up/Down Cutoff

The optics provide controlled uplight and downlight with side cutoft. The E5 Series optics are also available tor vertical mounting; add suffix "R" to catalog number.

NOTE: 50-watt MH with suffix "G" is supplied with a glass insert to allow operation in the wall-mounted position.

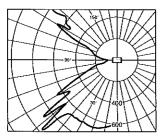


Candlepower Distribution Curve ot 50W HPS E5 Up/Down Cutoft Light.

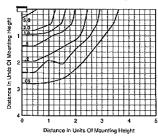


Isotootcandle plot of one 50W HPS E5 Up/Down Cutoff Light at 10' (3.0 m) mounting height (plan view).

E8 Series Deep Shielded


Front brightness shielding without sacrificing wide light distribution. The E8 works ideally over entrances.

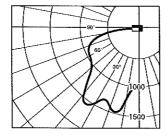

Candlepower Distribution Curve of 70W HPS E8 Deep Shielded Light.

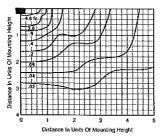

Isotootcandle plot of one 70W HPS E8 Deep Shielded Light at 15' (4.6 m) mounting height (plan view).

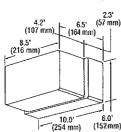

For 50, 70 and 100W HPS with quad-volt or tri-volt, and all MH fixtures, the housing depth is 3' (76 mm), and the overall fixture depth is 7.2" (183 mm).

led) nly)	Catalog Number E5405-MG E5503-1 E5505-1 E8405-M E8407-M E8503-1 E8505-1 E8507-1 E8510-1 is supplied.	Mounting Position Wall Any Any Wall Down! Wall Down! Any Any Wall Down! Wall Down! Change Suftix To 2	ight only
MH HPS HPS MH HPS HPS HPS W HPS glass insert led)	E5405-MG E5503-1 E5505-1 E8405-M E8407-M E8503-1 E8505-1 E8507-1 E8510-1	Wall Any Any Wall Downl Wall Downl Any Any Wall Downl Wall Downl Change Sultix To	ight only ight only ight only Add After
HPS HPS MH HPS HPS HPS W HPS glass insert led)	E5503-1 E5505-1 E8405-M E8407-M E8503-1 E8505-1 E8507-1 E8510-1	Any Any Wall Downl Wall Downl Any Any Wall Downl Wall Downl Change Sultix To	ight only ight only ight only Add After
HPS MH HPS HPS HPS W HPS glass insert led)	E5505-1 E8405-M E8407-M E8503-1 E8505-1 E8507-1 E8510-1	Any Wall Downl Wall Downl Any Any Wall Downl Wall Downl Change Sultix To	ight only ight only ight only Add After
MH MH HPS HPS HPS WHPS glass insert led)	E8405-M E8407-M E8503-1 E8505-1 E8507-1 E8510-1	Wall Down! Any Any Wall Down! Wall Down! Wall Down! Change Suftix To	ight only ight only ight only Add After
MH HPS HPS HPS WHPS glass insert led)	E8407-M E8503-1 E8505-1 E8507-1 E8510-1	Wall Down! Any Any Wall Down! Wall Down! Change Suftix To	ight only ight only ight only Add After
HPS HPS HPS W HPS glass insert led)	E8503-1 E8505-1 E8507-1 E8510-1	Any Any Wall Downl Wall Downl Change Sultix To	ight only ight only Add Affer
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HPS anly)		M	
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PS only)		T	
240V or 347V)		1, 2, 3, 4 or 6	Þ
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able on 100W	HPS)		GS
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both hpf and	d photocell su	pplied	
			V
alled)			
	Ca	italog Numb	er
		ESB-7	
		PAS-7	
		TPS-1	
Voltage Su	ttix Key		
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	s only) both hpf and (alled)	only) both hpt and photocell su lalled) Ca Voltage Suttix Key	s only) both hpf and photocell supplied (atled) Catalog Numb ESB-7 PAS-7

E5	Series	Mounting	Multi	pliers

Height	Multiplier	
7' (2.1 m)	2.04	_
8' (2.4 m)	1.56	_
9' (2.7 m)	1.23	_
10' (3.0 m)	1,00	_
12' (3.7 m)	0.69	_
15' (4.6 m)	0.44	_
20' (6.1 ៣)	0.25	

The E5 Series photometric data was developed in testing Ruud tixtures with clear, 50W HPS 4,000 lumen medium base lamps. Footcadhe readings for other wattages and lamp types may be obtained by multiplying the chart values by the toflowing:

tonoming.		
Lamp/Watlages	Multiplier	
50W MH	0.85	
35W HPS	0.56	

E8 Series Mounting Multipliers

Multiplier	
3.52	
2.25	
1.56	
1,00	
0.56	
0.36	
	3.52 2.25 1.56 1.00 0.56

The E Series photometric data in this section was developed in testing Ruud fixtures with clear, 70W HPS 6,400 lumen medium base lamps. Footcandle readings for other wattages and lamp types may be obtained by multiplying the chart values by the following:

HE KHOWING.		
Lamp/Wattages	Multiplier	
50W MH	0.53	
70W MH	0.86	
35W HPS	0.35	
50W HPS	0.63	
100W HPS	1.48	
		_

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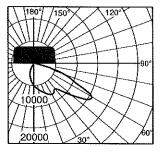
Fax: (800) 236-7500 • www.ruudlighting.com




This compact forward-throw reflector has a main beam of 60+ degrees from vertical (30 degrees from horizontal), providing wide lateral distribution and excellent uniformities. A Backlight Shield accessory (standard on Wall Mount) permits precise cutoff adjustability.

Three Sizes:

12" square x 5" deep (305 x 127 mm) 16" square x 6.5" deep (406 x 165 mm) 22" square x 9.3" deep (559 x 235 mm)



Candlepower distribution curve of 400W MH 16° Area Cutoff Light. (Side View)

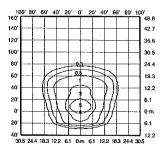

Isofootcandle plot of 400W MH Area Cutoff Light at 30' (9.1 m) mounting height, 0° tilt above horizontal, with backlight shield removed.

		Order Inf	ormation
Housing	Wattage/	Catalog	Mounting Code
Size (sq.	Lamp	Number	(insert Code at * in Catalog #)
12"	150W PSMH	MAC <u>*</u> 615-M	1 = 1-1/2" Close Pole Mount
16"	150W PSMH	AC <u>*</u> 615-M	2 = 6" Extended Pole Mount
16°	250W PSMH	AC <u>*</u> 625-M	3 = 2" Adjustable Filter
16 * ()	320W PSMH	AC_632-M	4 = Yoke Mount
16"	400W PSMH	AC <u>*</u> 640-M	6 = 1/2" Adjustable Fitter
22"	750W PSMH	AC <u>*</u> 675-M	(12" housing only)
12*	50W MH	MAC <u>*</u> 405-M	8 = Without Mounting (hardware)
12*	70W MH	MAC <u>*</u> 407-M	K = Round Tube Oti-Center
12°	100W MH	MAC <u>*</u> 410-M	Tenon Mount (16" housing only)
12"	175W MH ◀	MAC <u>*</u> 417-M	(For 2-3/8" or 3" O.D.)
16"	175W MH ◀	AC <u>*</u> 417-M	M = Round Tube Off-Center
16"	250W MH ◀	AC <u>*</u> 425-M	Direct Mount (16* housing only)
<u>16*</u> ♥	400W MH ◀	AC <u>*</u> 440-M	(Direct Fitter for 4" sq. pole)
22.	1000W MH	AC <u>*</u> 499-M	W = Wall Mount
12"	35W HPS	MAC <u>*</u> 503-1	(Backlight Shield is standard)
12"	50W HPS	MAC <u>*</u> 505-D	
12"	70W HPS	MAC <u>*</u> 507-M	NOTE: When using multiple 22" sq.
12"	100W HPS	MAC <u>*</u> 510-M	housings at 90° configuration, a special 12" arm is required; see page 148.
12*	150W HPS	MAC <u>*</u> 515-M	та жин в тоцинов, эсе раде 140.
16"	250W HPS	AC <u>*</u> 525-M	
16"	400W HPS	AC <u>*</u> 540-M	

- ◀ Some states prohibit these products from being sold.
- * Specify Mounting (additional cost)

Other lamp waltages available-consult tactory

P Reduced envelope lamp. ED28 for 320 & 400W PSMH and 400W MH; BT37 for 1000W MH. Options: (Factory-installed) Change Suffix To Suffix Description Suffix To Suffix 120V Reactor ballast (50–150W HPS 12* housing enly) 1 277V Reactor ballast (PSMH only) 27 347V ballast (50W HPS only) 6 480V ballast (PSMH, 175–1000W MH & 70–400W HPS only) 5 480V ballast (PSMH, MH & 70–400W HPS only) 1 27ini-volt ballast (PSMH, MH & 70–400W HPS only) 1 27ini-volt ballast (PSMH, MH & 70–400W HPS only) 7 27ini-volt ballast (PSMH, MH & 70–400W HPS only) 7 27ini-volt ballast (PSMH, MH & 70–400W HPS only) 7 27ini-volt ballast (PSMH, MH & 70–400W HPS only) 7 27ini-volt ballast (PSMH, MH & 70–400W HPS only) 7 27ini-volt ballast (PSMH, MH & 70–400W HPS only) 7 27ini-volt ballast (PSMH, MH & 70–400W HPS only) 7 27ini-volt ballast (PSMH, MH & 70–400W HPS only) 7 27ini-volt ballast (PSMH, MH & 70–400W HPS only) 7 27ini-volt ballast (PSMH, MH & 70–400W HPS only) 7 27ini-volt ballast (PSMH, MH & 70–400W HPS only) 7
Description Suftix To Suffix
120V Reactor ballast (50–150W HPS 12* housing only) 1 277V Reactor ballast (PSMH only) 27 347V ballast (50W HPS only) 6 480V ballast (FSMH, 175–1000W MH & 70–400W HPS only) 5 480V ballast (70–160W MH only) 5 5 5 5 5 5 5 5 5
277V Reactor ballast (PSMH only) 27 347V ballast (sow HPS only) 6 480V ballast (PSMH, 175–1000W MH & 70–400W HPS only) 5 480V ballast (PSMH, MH & 70–400W HPS only) 5 71i-volt ballast (PSMH, MH & 70–400W HPS only) 1 Single Fuse (277V Reactor, 120V, 277V or 347V) 27, 1, 2 or 6 F Dual Fuse (208V, 240V or 480V) (n/a Canada) 3, 4 or 5 F Quartz Standby (delay-relay type) (includes 100W Q lamp) (n/a 277V Reactor) 0 Button Photocell (Factory-installed with ail mountings other than 2* Adjustable Fitter) NOTE: n/a on 1000W w/120V; all 480V 27, 1, 2, 3, 4 or 6 P External Photocell (Factory-installed) (Page 131) For fixtures w/1000W, 120V 1 P For fixtures w/1000W, 120V 1 P P For fixtures w/480V 5 P P Accessories: (Field-installed) 12" 16" 22" Wire Guard FWG-12 FWG-16 FWG-22 Backlight Shield SBL-12 SBL-16 SBL-22 (standard on AC Series Wall Mount) Button Photocell (Field-installed in fixtures with 2* Adjustable Fitter) Catalog # For fixtures
347V ballast (50W HPS only) 6
ABOV ballast (PSMH, 175—1000W MH & 70–400W HPS only) 5
ABOV ballast (70–100W MH only) 5
Tri-volt ballast (PSMH, MH & 70 - 400W HPS only) T
Single Fuse (2777 Reactor, 1207, 277 or 3477) 27, 1, 2 or 6 F
Dual Fuse (208V, 240V or 480V) (n/a Canada) 3, 4 or 5 F
Quartz Standby (delay-relay type) (includes 100W Q lamp) (n/a 277V Reactor) 0 Button Photocell (Factory-installed with all mountings other than 2' Adjustable Fitter) NOTE: n/a on 1000W w/120V; all 480V 27, 1, 2, 3, 4 or 6 P External Photocell (Factory-installed) (Page 131) P For fixtures w/1000W, 120V 1 P For fixtures w/1000W, 120V 5 P P Accessories: For fixtures w/480V 5 P Accessories: FWG-12 FWG-16 FWG-22 Backlight Shield SBL-12 SBL-16 SBL-22 Standard on AC Series Wall Mount) Button Photocell (Field-installed in fixtures with 2' Adjustable Fitter) Catalog # For tixtures w/120V (n/a on 1000W) PC-1 PC-2 For fixtures w/208, 240 or 277V PC-2 PC-6 Mountings Page 114 Catalog Number Logic/Voltage Suftix Key Page 113 Optical Systems Pages 102-105 Accessories Pages 148-149
Button Photocell (Factory-installed with all mountings other than 2' Adjustable Fitter) NOTE: n/a on 1000W w/120V; all 480V
NOTE: n/a on 1000W w/120V; all 480V 27, 1, 2, 3, 4 or 6 P External Photocell (Factory-installed) (Page 131) For fixtures w/1000W, 120V 1 P For fixtures w/480V 5 P Accessories: (Field-installed) 12" 16" 22" Wire Guard FWG-12 FWG-16 FWG-22 Backlight Shield SBL-12 SBL-16 SBL-22 Standard on AC Series Wall Mount) Button Photocell (Field-installed in fixtures with 2' Adjustable Fitter) Catalog # For tixtures w/120V (n/a on 1000W) PC-1 PC-2 For fixtures w/208, 240 or 277V PC-2 For fixtures w/347V PC*6 Mountings Page 114 Catalog Number Logic/Voltage Suftix Key Page 113 Optical Systems Pages 102-105 Accessories Page 131 Mounting Alternatives Pages 148-149
External Photocell (Factory-installed) (Page 131) For fixtures w/1000W, 120V
For fixtures w/1000W, 120V 1 P For fixtures w/480V 5 P Accessories: (Field-installed) 12" 16" 22" Wire Guard FWG-12 FWG-16 FWG-22 Backlight Shield SBL-12 SBL-16 SBL-22 (standard on AC Series Wall Mount) Button Photocell (Field-installed in fixtures with 2' Adjustable Fitter) Catalog # For tixtures w/120V (n/a on 1900W) PC-1 For fixtures w/208, 240 or 277V PC-2 For fixtures w/347V PC*6 Mountings Page 114 Catalog Number Logic/Voltage Suftix Key Page 113 Optical Systems Page 131 Mounting Alternatives Pages 148-149
For fixtures w/480V 5 P Accessories: (Field-installed) 12" 16" 22" Wire Guard FWG-12 FWG-16 FWG-22 Backlight Shield SBL-12 SBL-16 SBL-22 (standard on AC Series Wall Mount) Button Photocell (Field-installed in fixtures with 2' Adjustable Fitter) Catalog # For tixtures w/120V (n/a on 1900W) PC-1 PC-2 For fixtures w/208, 240 or 277V PC-2 PC*6 Mountings Page 114 Catalog Number Logic/Voltage Suftix Key Page 113 Optical Systems Pages 102-105 Accessories Page 131 Mounting Alternatives Pages 148-149
Accessories: (Field-installed) 12" 16" 22" Wire Guard FWG-12 FWG-16 FWG-22 Backlight Shield SBL-12 SBL-16 SBL-22 (standard on AC Series Wall Mount) Button Photocell (Field-installed in fixtures with 2' Adjustable Fitter) Catalog # For tixtures w/120V (n/a on 1900W) PC-1 PC-2 For fixtures w/208, 240 or 277V PC-2 PC*6 Mountings Page 114 Catalog Number Logic/Voltage Suftix Key Page 113 Optical Systems Pages 102-105 Accessories Page 131 Mounting Alternatives Pages 148-149
(Field-installed) 12" 16" 22" Wire Guard FWG-12 FWG-16 FWG-22 Backlight Shield SBL-12 SBL-16 SBL-22 (standard on AC Series Wall Mount) Button Photocell (Field-installed in fixtures with 2' Adjustable Fitter) Catalog # For tixtures w/120V (n/a on 1000W) PC-1 PC-2 For fixtures w/347V PC-2 PC'6 Mountings Page 114 Catalog Number Logic/Voltage Suftix Key Pages 102-105 Accessories Page 131 Mounting Alternatives Pages 148-149
Wire Guard FWG-12 FWG-16 FWG-22 Backlight Shield SBL-12 SBL-16 SBL-22 (standard on AC Series Walf Mount) Button Photocell (Field-installed in fixtures with 2' Adjustable Fitter) Catalog # For tixtures w/120V (n/a on 1000W) PC-1 PC-2 For fixtures w/208, 240 or 277V PC-2 PC*6 Mountings Page 114 Catalog Number Logic/Voltage Suftix Key Page 113 Optical Systems Page 131 Mounting Alternatives Pages 148-149
Backlight Shield SBL-12 SBL-16 SBL-22
(standard on AC Series Wall Mount) Button Photocell (Field-installed in lixtures with 2° Adjustable Fitter) Catalog # For tixtures w/120V (n/a on 1000W) PC-1 For lixtures w/208, 240 or 277V PC-2 For lixtures w/347V PC*6 Mountings Page 114 Catalog Number Logic/Voltage Suftix Key Page 113 Optical Systems Pages 102–105 Accessories Page 131 Mounting Alternatives Pages 148–149
Button Photocell (Field-installed in fixtures with 2° Adjustable Fitter)
For tixtures w/120V (n/a on 1000W) PC-1 For fixtures w/208, 240 or 277V PC-2 For fixtures w/347V PC*6 Mountings Page 114 Catalog Number Logic/Voltage Suffix Key Page 113 Optical Systems Pages 102–105 Accessories Page 131 Mounting Alternatives Pages 148–149
For lixtures w/208, 240 or 277V PC-2 For lixtures w/347V PC*6 Mountings Page 114 Catalog Number Logic/Voltage Suffix Key Pages 102–105 Optical Systems Pages 102–105 Accessories Page 131 Mounting Alternatives Pages 148–149
For lixtures w/347V PC*6 Mountings Page 114 Catalog Number Logic/Voltage Suftix Key Page 113 Optical Systems Pages 102–105 Accessories Page 131 Mounting Alternatives Pages 148–149
Mountings Page 114 Catalog Number Logic/Voltage Suftix Key Page 113 Optical Systems Pages 102–105 Accessories Page 131 Mounting Alternatives Pages 148–149
Mountings Page 114 Catalog Number Logic/Voltage Suftix Key Page 113 Optical Systems Pages 102–105 Accessories Page 131 Mounting Alternatives Pages 148–149
Optical Systems Pages 102–105 Accessories Page 131 Mounting Alternatives Pages 148–149
Accessories
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Two optical systems are available:

Vertical Lamp, for 50- to 175-watt medium-base lamps.

Horizontal Lamp, for 175- to 400-watt mogul-base lamps.


Both provide quadrate distribution and great unity mitter. The optical

Both provide quadrate distribution and great uniformities. The optical chamber is sealed to reduce dirt and insect contamination.


One Size:

16" square x 6.5" deep (406 x 165 mm)

Vertical Lamp Optics

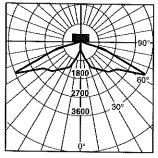


Candlepower Distribution Curve of 16° square 175W MH Vertical Lamp Post Top Light.

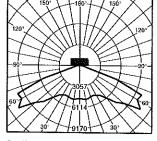


Horizontal Lamp Optics

Candlepower Distribution Curve of 16' square 400W MH Horizontal Lamp Post Top Light.

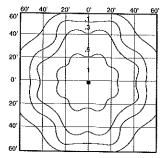

tsofootcandle plot of 16' square 175W MH Vertical Lamp Post Top Light at 20' (6.1 m) mounting height.

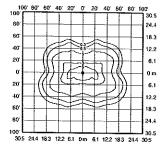

Isofootcandle plot of 16" square 400W MH Horizontal Lamp Post Top Light at 25' (7.6 m) mounting height.

		ការក្មេរ	Information
Housing	Wattage/	Catatog	Mounting Code
Size (sq.) Lamp	Number	(Insert Code at * in Catalog #)
Verlical I	amp Dptics.	:	F = Center Tenon Mount
16"	150W PSMH	QV <u>*</u> 615-M	(Tenon Fitter for 2-3/8" up to 3" O.D.)
16"	50W MH	QV <u>*</u> 405-M	H = Center Direct Mount
16"	70W MH	QV <u>*</u> 407-M	(Direct Fitter for 4" sq. pole)
16"	100W MH	QV <u>*</u> 410-M	Also available with side pole mount:
16"	175W MH ◀	QV <u>*</u> 417-M	1 = 1-1/2" Close Pole Mount
16"	50W HPS	QV <u>*</u> 505-D	2 = 6" Extended Pole Mount
16"	70W HPS	QV <u>*</u> 507-M	***************************************
16"	100W HPS	QV <u>*</u> 510-M	
Horizonta	ıl Lamp Opti	cs:	F = Center Tenon Mount
16"	150W PSMH	QH <u>*</u> 615-M	(Tenon Fitter for 2-3/8" up to 3" O.D.)
16"	250W PSMH	QH <u>*</u> 625-M	H = Center Direct Mount
16" 🌵	320W PSMH	QH <u>*</u> 632-M	(Direct Fitter for 4" sq. pole)
16" 🏚	400W PSMH	QH <u>*</u> 640-M	
16*	175W MH ◀	QH <u>*</u> 417-M	
16°	250W MH ◀	QH <u>*</u> 425-M	
16"	400W MH ◀	QH <u>*</u> 440-M	
16"	250W HPS	QH <u>*</u> 525-M	
16"	400W HPS	QH*540-M	

- Some states prohibit these products from being sold.
- * Specify Mounting (additional cost)

Other famp wattages available—consult factory

P Reduced envelope lamp, ED28 for 320 & 400W PSMH.

Options: (Factory-installed)	Change	Add After
Description	Suffix To	Sulfix
277V Reactor ballast (PSMH only)	27	
347V ballast (50W HPS only)	6	
480V ballast (PSMH, 175-400W MH & 70-400W HPS only)	5	*****

347V ballast (56W HPS only)

480V ballast (PSMH, 175-400W MH & 70–400W HPS only)

5
480V ballast (PSMH, 175-400W MH only)

5
Tri-volt ballast (PSMH, MH & 70–400W HPS only)

5
Tri-volt ballast (PSMH, MH & 70–400W HPS only)

T
Single Fuse (277V Reactor, 120V, 277V or 347V)

27, 1, 2 or 6

F
Dual Fuse (208V, 240V or 480V) (n/a Canada)

3, 4 or 5

F
Quartz Standby (delay-relay type) (includes 100W 0 tamp) (n/a 277V Reactor)

Button Photocell (n/a on 480V)

External Photocell (480V only) (Page 131)

Accessory: (Field-installed)

Description	Catalog Number
Wire Guard	EUO 10
Mountings	Page 114
Catalog Number Logic/Voltage Suffix Key	Page 113
Optical Systems	Pages 102–105
Accessories	
Mounting Alternatives	
Mounting Brackets	Pages 150–151
Poles	

Customer Service... DIRECT!

(800) 236-7000, 7 a.m. to 6 p.m. CT Fax: (800) 236-7500 • www.ruudlighting.com

Specification Sheet



Monogram 46

Vinyl Siding

General Description: MonogramTM provides the look of wood siding, but does not require the upkeep common to wood. Monogram siding is manufactured with TrueTextureTM rough cedar finish molded directly from real cedar boards. Available in a selection of profiles, Monogram offers the industry's widest selection of colors. It is appropriate for use in new construction for single family homes, multi-housing projects and light commercial developments. Monogram is also an ideal product for remodeling.

Styles:

Profile	Finish	Panel Projection (Nominal)	Wall Thickness (Nominal)	Lock Design	Colors	Accessory Pocket
Double 4" Clapboard	Rough Cedar	3/4"	.046"	CertiLock [™] post-formed positive lock	41	3/4"
Double 5" Clapboard	Rough Cedar	3/4"	.046"	CertiLock [™] post-formed positive lock	19	3/4"
Double 5" Dutchlap	Rough Cedar	3/4"	.046"	CertiLock [™] post-formed positive lock	27	3/4"

Colors: Monogram siding profiles are available in the industry's widest selection of colors. All colors are Spectrophotometer controlled and utilize exclusive PermaColorTM color science.

Arbor Blend**	Cypress	Heritage Cream	Pacific Blue*	Sterling Gray
Arctic Blend**	Desert Tan	Herringbone	Sable Brown*	Suede
Autumn Red*	Flagstone*	Ivy Green*	Sandpiper	Terra Cotta*
Autumn Yellow	Forest*	Light Maple	Sandstone Beige	Timber Blend**
Bermuda Blue	Frontier Blend**	Linen	Savannah Wicker	Weathered Blend**
Buckskin	Glacier Blend*	Meadow Blend*	Seagrass	
Canyon Blend*	Granite Gray	Mountain Cedar*	Silver Ash	
Charcoal Gray*	Green Tea	Natural Clay	Snow	
Colonial White	Hearthstone*	Oxford Blue	Spruce*	

^{*} Deluxe Color: Deluxe colors utilize CertainTeed's proprietary manufacturing process to provide the unique appearance of semi-transparent and solid stained wood siding.

STUDfinderTM: The patented STUDfinder Installation System combines precisely engineered nail slot locations with graphics. Nail slots are positioned 16" on center to allow for alignment with studs. STUDfinder graphics centered at each slot provide a quick and easy guide to help locate studs.

RigidFormTM: Monogram RigidForm 220 technology has a stiff, double-thick .092" nail hem for a straighter-on-the-wall appearance and wind load performance.

Lock: Uniquely designed for ease of installation, Monogram features the CertiLock™ locking system; a post-formed positive lock which provides for self-aligning installation. Properly installed panels will snap together with an audible "click" signaling that they are ready for nailing.

Accessories: CertainTeed manufactures a wide range of siding accessories which are compatible with Monogram siding styles and colors. Accessory products include installation components, soffit, window and door trim, comer lineals, corner systems and decorative moldings.

^{**} Premium Color: Made with an exclusive, highly durable polymer capstock combined with unique heat distortion modifiers that helps ensure long-term weatherability in darker hues that would otherwise quickly fail.

Composition: Monogram siding products are produced using CertaVinTM custom-formulated PVC resin. This resin is produced exclusively by CertainTeed, allowing CertainTeed to maintain the high quality of its siding products.

Technical Data: Monogram siding is in compliance with ASTM specification for Rigid Polyvinyl Chloride (PVC) Siding Insulated Vinyl Siding D 3679, and the requirements of section R703.11 of the International Residential Code, and section 1405.14 and 2603 of the International Building Code. Monogram siding meets or exceeds the properties noted in Table 1.

ASTM E 84	Meets Class 1 flame spread requirements as tested according to ASTM E84.
ASTM D 1929	Self-ignition temperature 813°F
ASTM D 635	Material is self-extinguishing with no measurable extent of burn when tested in accordance with this specification.
NFPA 268	Radiant Heat Test - Ignition Resistance of Exterior Walls - Conclusion that CertainTeed met the conditions for
	allowable use as specified in section 1406 of the International Building Code.

Important Fire Salety Information: When rigid vinyl siding is exposed to significant heat or flame, the vinyl will soften, sag, melt or burn, and may thereby expose material underneath. Care must be exercised when selecting underlayment materials because many underlayment materials are made from organic materials that are combustible. You should ascertain the fire properties of underlayment materials prior to installation. All materials should be installed in accordance with local, state and federal Building Code and fire regulations.

Wind Load Testing: CertainTeed Monogram double 4" siding has been tested per ASTM D 5206 standard test method for resistance to negative wind load pressures of 63 psf, which equates to more than 220 mph per VSI windspeed calculation guidelines, when installed with nails positioned 16" on center. Check with your local building inspector for wind load requirements in your area on the type of structure you are building.

Documents: CertainTeed Vinyl Siding meets the requirements of one or more of the following specifications.

Texas Department of Insurance Product Evaluation EC-11

Conforms to ASTM Specification D3679

Florida BCIS Approval FL1573

ICC-ES Evaluation Report ESR-1066

CCMC #13008-L

For specific product evaluation/approval information, call 800-233-8990.

Installation: Prior to commencing work, verify governing dimensions of building, examine, clean and repair, if necessary, any adjoining work on which the siding is in any way dependent for its proper installation. Sheathing materials must have an acceptable working surface. Siding, soffit and accessories shall be installed in accordance with the latest editions of CertainTeed installation manuals on siding and soffit. Installation manuals are available from CertainTeed and its distributors.

Warranty: CertainTeed supports Monogram siding products with a Lifetime Limited Warranty including PermaColor Lifetime Fade Protection to the original homeowner. The warranty is transferable if the home is sold.

Technical Services: CertainTeed maintains an Architectural Services staff to assist building professionals with questions regarding CertainTeed siding products. Call 800-233-8990 for samples and answers to technical or installation questions.

Sample Short Form Specification: Siding as shown on drawings or specified herein shall be Monogram Vinyl Siding as manufactured by CertainTeed Corporation, Valley Forge, PA. The siding shall have a .092" thick nail hem. Installation shall be in accordance with manufacturer's instructions.

Three-part Format Specifications: Long form specifications in three-part format are available from CertainTeed by calling our Architectural Services Staff at 800-233-8990. These specifications are also available on our website at certaintced.com.



CertainTeed Corporation P.O. Box 860 Valley Forge, PA 19482 ccrtainteed.com © 12/13

January 30, 2015

Mr. Tom Hovel
City Planner
Department of Planning and Development
City of Fitchburg
5520 Lacy Road
Fitchburg WI 53711

Re: City Staff Comments
Lacy Rd. and Syene Rd. - Lot 3

KBA Project # 1332

Dear Mr. Hovel,

We have reviewed city staff comments. Please see our responses in red below and contact Jim Beltran with any questions.

City Staff Comments

- An Administrative Waiver form was completed but was lacking supporting materials. No description was provided specifying what the Waiver is for. Please add the required supplemental information as detailed on the application form. Supplemental information has been added.
- 2.) The plan indicates that the size of the site is 37,077 square feet. The plat shows Lot 3 containing 46,698 sq ft. Please explain this difference. 46,698 SF is correct. Plans and application have been updated accordingly.
- 3.) Please better distinguish the property line on plan sheet C-1.1 as it's a bit hard to identify. Line weight has been adjusted.
- 4.) An Administrative Approval is needed for:
 - a. Edgeyard Building in T5
 - b. For the additional recess behind the Primary Setback to count toward the Frontage Buildout. See section 5.6.2.f.vii for additional information. You will need to provide a calculation showing that at least 66% of each Façade (street elevation) is built at or up to 18" behind the primary setback. You should also show or indicate that the mechanical louver will be placed on the side recess wall. See item #1's response.

Please complete an Administrative Approval application form for each of these items. The AA form is available at http://www.fitchburgwi.gov/DocumentCenter/View/618. These will be included with the ADR request for the Plan Commission to act on.



- 5.) An Administrative Waiver is required to use a hedge for streetscreen in non-parking area. Perhaps this is what the Administrative Waiver form was submitted for in item 1? Yes. One of them applies to the use of a hedge.
- 6.) Signage shall comply with Chapter 23 SmartCode. Plan sheet G-1.1 shows signage on the retaining wall; please note that the SmartCode does not allow for retaining wall signs and should be removed from the plan sheet. Note has been removed. Signage will be determined later.
- 7.) I believe that the labels for the elevations on plan sheet A-2.2 are incorrect. It appears that the elevation labeled "West elevation" is in face the south elevation and the elevation labeled "South elevation" is the east elevation. Please update plan sheets appropriately to reflect the correct elevation. Labels have been corrected.
- 8.) The application states that the lot width is 180 feet. Please confirm if this is correct. Lot width on the primary frontage side is 169'-0". Application has been updated accordingly.
- 9.) Parking: Plan sheet C-1.1 notes that there are 60 underground stalls but the engineering drawings and landscaping plan note 59. Please be consistent. This has been corrected.
 - Similarly, sheet C-1.1 notes that there are 33 surface parking stalls, but I count 34 (including handicap). You should also be aware that only ½ of the available parking along the parking land corresponding to the lot Frontage for residential use counts toward the parking. Given this, you can count 5 street parking stalls to your parking totals. Parking counts have been revised.
- 10.) What is the pitch of the roof? 4.25/12
- 11.) Please confirm that all exterior lighting fixtures are dark sky or full cutoff as not all the cut sheets specified. Yes. Light fixtures are dark sky compliant. The requirement for necessary cutoffs has been noted on the site lighting plan.
- 12.) Due to the increased building articulation and use of vinyl siding, this plan requires approval from the City's Plan Commission. This request is scheduled to be on the Commission's February 17, 2015 Plan Commission agenda.
- 13.) Park Improvement Fee: The developer paid \$47,600 (check # 000004) in park improvement fees for 340 dwelling units. This amount was based on five, 68-unit buildings in the North Park Plat.

Lot 4 – 68 units Lot 3 – 71 units Lot 5 71 units

With development of Lots 3, 4 & 5, there is a remaining balance of park improvement fee for 130 units. Please note that if the future development on Lots 1 & 2 exceeds 130 units, additional park improvement fee will need to be collected.

Sincerely,

February 3, 2015

Mr. Cory Horton
Director of Public Works
Department of Public Works
City of Fitchburg
5520 Lacy Road
Fitchburg WI 53711

Re: Public Works Review Comments Lacy Rd. and Syene Rd. – Lot 3

KBA Project # 1332

Dear Mr. Horton,

We have reviewed the Public Works comments. Please see our responses in red below and contact Jim Beltran with any questions.

Public Works Review Comments

General Comments

- 1. Please confirm that refuse and recycling container(s) are located and sized properly. Trash enclosure is located within the basement. Size is adequate.
- 2. The applicant will need to submit a Construction & Demolition Reuse/Recycling Plan to Public Works. This will be completed prior to construction.
- 3. Please note on the plans that a street opening permit is required for all work within the right-of-way and that all work performed in the right-of-way needs to be completed in accordance with the latest edition of the City of Fitchburg's Standard Specifications or Public Works Construction. Requirement has been added to C-1.1.

Transportation Comments

- Driveways should follow the Commercial Driveway Standards of the City of Fitchburg, consisting of a
 concrete apron and straight tapers to meet the public street. This drawing can be found in the City's
 Standard Specifications document, available on our website:
 http://www.city.fitchburg.wi.us/departments/cityHall/publicWorks/documents/StandardSpecifications.p
 df Requirement has been added to C-1.1.
- 2. The bike parking areas that are located adjacent to public sidewalk shall provide a minimum 2-ft clear zone between the edge of the sidewalk and a parked bicycle. To maintain this clearance, bike racks that are perpendicular to the sidewalk should be mounted no closer than 4' to the edge of the sidewalk. See detail 6 / C-1.1.
- 3. Sidewalk adjacent to Lot 3 shall be installed per the First Amendment to the Agreement for Subdivision Improvements in the Plat of North Park (Documents #5116733). Will comply.
- Label expansion joint between private stairs and public sidewalk. Requirement has been added to C-1.1.



- 5. The City is still deciding on a pedestrian-scale street light which will be located in the terrace area between the sidewalk and the curb and gutter. It is likely that at least one new street light, possibly 2, will be required along N. Park Lane within the limits of the street frontage for Building 2. Understood.
- 6. The bike path along Lacy Road shall remain open during construction and shall not be used by the building contractor. Any damages to the path, caused by the building construction, shall be repaired prior to occupancy. Understood. This has been noted on C-1.1.

Water Main and Sanitary Sewer

- 1. Water impact fees will need to be paid prior to release of any building permits. These fees will be included with the permit fee. The 2015 impact fee rate is \$729/Unit. Understood.
- 2. If Syene Interceptor fees have not been paid for the North Park development. Per the Agreement for Subdivision improvements, once these fees are invoiced they will need to be paid within 30 days. Understood.


Erosion Control and Stormwater Management (ECSWM) Comments

- A new Erosion Control & Storm Water Management permit application will need to be submitted to the Fitchburg Public Works Department for review and approval (The ECSWM application and information on requirements can be found at: http://www.fitchburgwi.gov/231/ECSWM-Requirements.
 Will comply.
- 2. A stormwater maintenance agreement (recorded at the Dane County Register of Deeds office) will be required for the necessary private stormwater management practices approved by the City (e.g. private storm sewer, rain gardens, etc.). The owner(s) would be eligible for up to a 50% reduction in stormwater utility rates for the proposed stormwater practices. The following link: http://www.fitchburgwi.gov/230/Credit-Opportunities provides the application form and details on this program. Will comply.
- 3. This site is within the McGaw Park Neighborhood which has stormwater performance standards (e.g. 100% stay-on infiltration volume, etc.) described in the approved plan at: http://wi-fitchburg.civicplus.com/385/McGaw-Park-Neighborhood-Plan. The designer may contact Fitchburg's Environmental Engineer at 270-4264 or rick.eilertson@fitchburgwi.gov if he/she has any questions on ECSWM performance standards for this site. Will.comply.
- 4. Please confirm the elevations of the parking lot over the existing storm sewer between North Park Lane and the stormwater pond on Outlot 6. This is an anticipated overflow route for events larger than the 100 year design storm and it's critical to ensure these extreme events don't flood out adjacent structures. Vierbicher has reviewed these elevations and modified where necessary. See revised plan.

Sincerely,

J. Randy Bruce Managing Member

SHEET INDEX: SITE C-1.0 OVERALL SITE PLAN C-1.1 ENLARGED SITE PLAN C-1.2 SITE LIGHTING PLAN C-2.0 GRADING & EROSION CONTROL PLAN C-3.0 SITE UTILITY PLAN L-1.0 LANDSCAPE PLAN ARCHITECTURAL A-1.0 BASEMENT PLAN A-2.1 ELEVATIONS A-2.2 ELEVATIONS

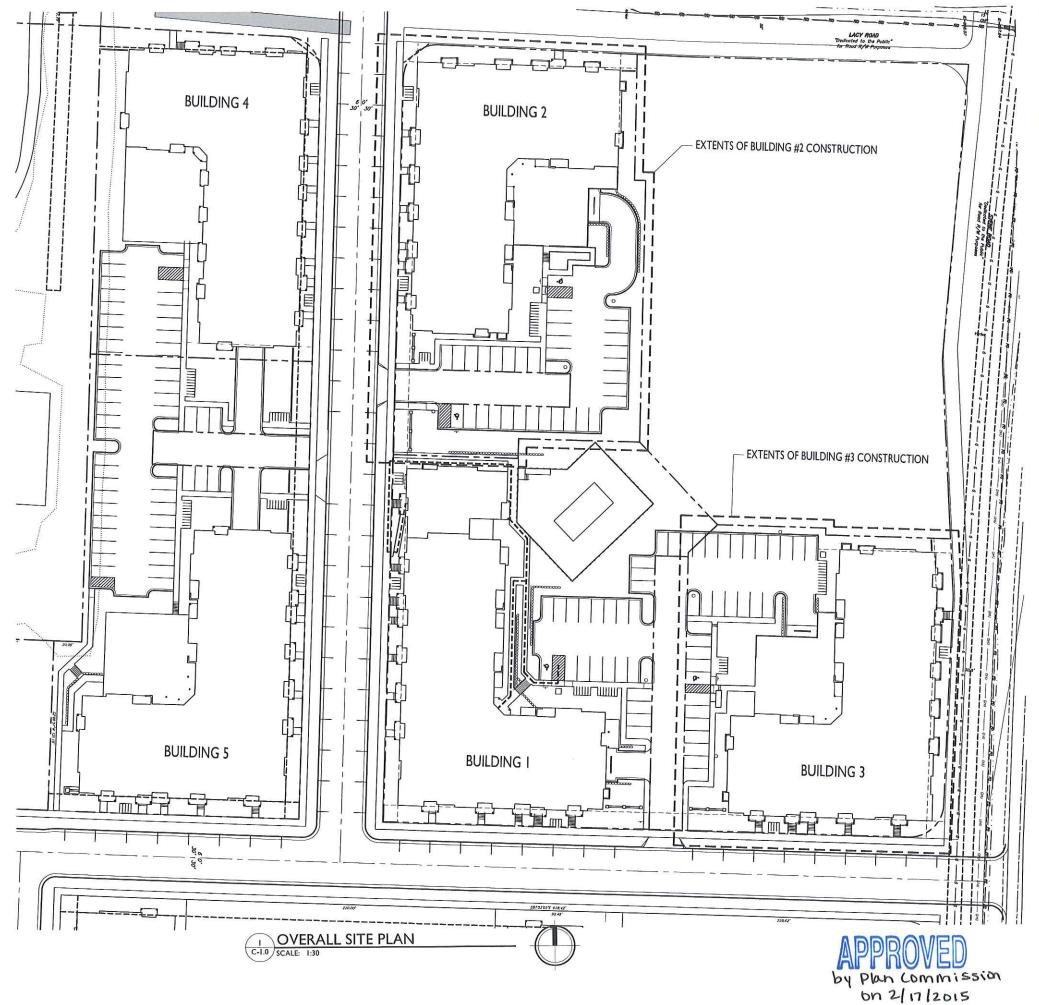

knothe bruce
ARCHITECTS
Phons: 7601 University Ave, Ste 201
608.316.3590 Middleton, WI 53562

ISSUED
Article 5 Submittal: January 15, 2015
Article 5 Re-Submittal: February 5, 2015

PROJECT TITLE
THE ADDISON
BUILDING 2


NORTH PARK LANE & LACY ROAD SHEET TITLE SITE PLAN


SHEET NUMBER

C-1.0


PROJECT NO. 1332


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ISSUED
Article 5 Submittal: January 15, 2015
Article 5 Re-Submittal: February 5, 2015

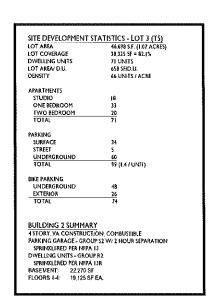THE ADDISON
BUILDING 2

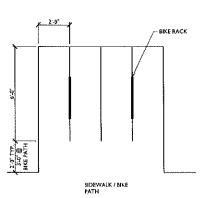NORTH PARK LANE & LACY ROAD SHEET TITLE SITE PLAN


SHEET NUMBER

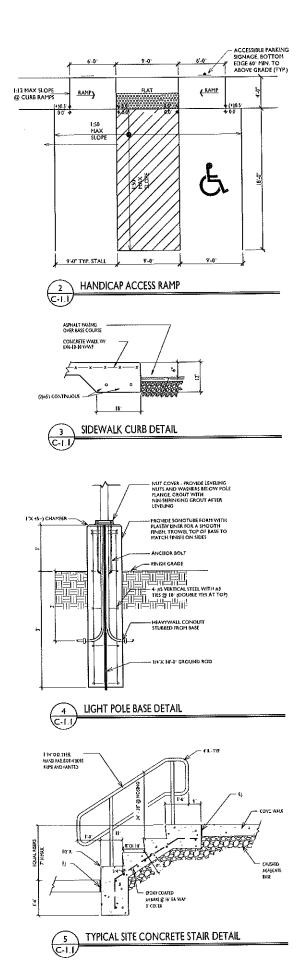C-1.1

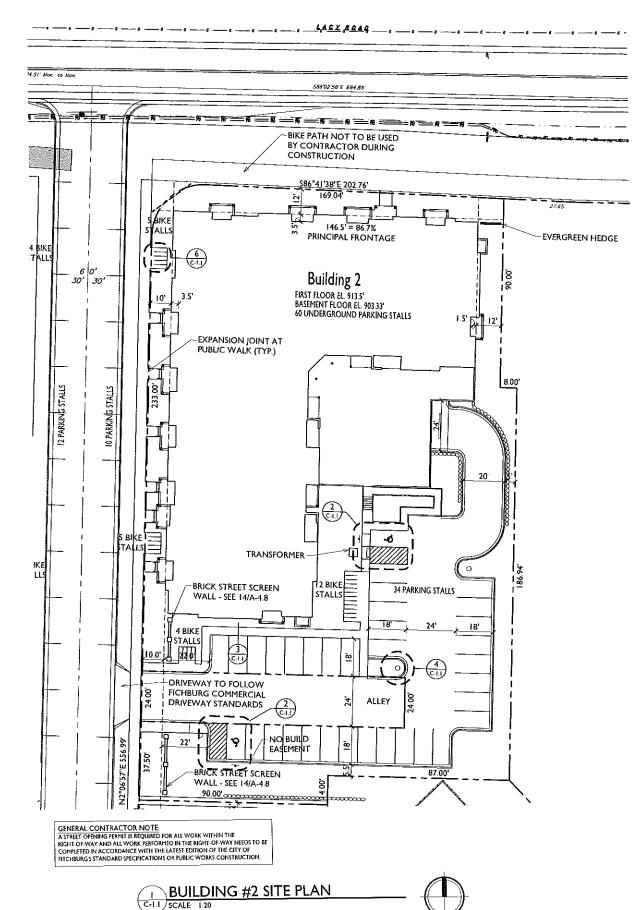PROJECT NO. 1332

Synte)	Label	Otγ	Manufacturez	Calalog blumber	Description	Lamp	File	Mounting
	Α	2	RUUD LIGHTING	E8405	RECTANGULAR SECURITY / DEEP SHIELDED	501VATT MH	E8507.IES	8'-0' AOVE GRADE ON SIDE OF BUILDING
尊	В	3	RUUD LIGHTING	MAC410SBL	12" AREA CUTOFF / WBACK LT, SHIELD	100 WATEMH	MAC4175BLJe	16'-0" POLE ON 2'-0" TALL CONC, BASE
횩	С	3	RUUD LIGHTRIG	QV410	16" DUADRATE VERTICAL / TYPE V	100 WATT MH	QV4171es	16'-0' POLE OH 2'-0" TALL CONG, BASE

LIGHTING STATISTICS						
Description	Symbol	Avg	Max	1.720	MacMin	AvgħGn
Parking	+	1.2 fc	8.3 fc	0.3 la	27.7:1	4.0.1
Pool and Deck	+	10.5 fc	17.6 fc	3.0 fc	5.9:1	3.5:1

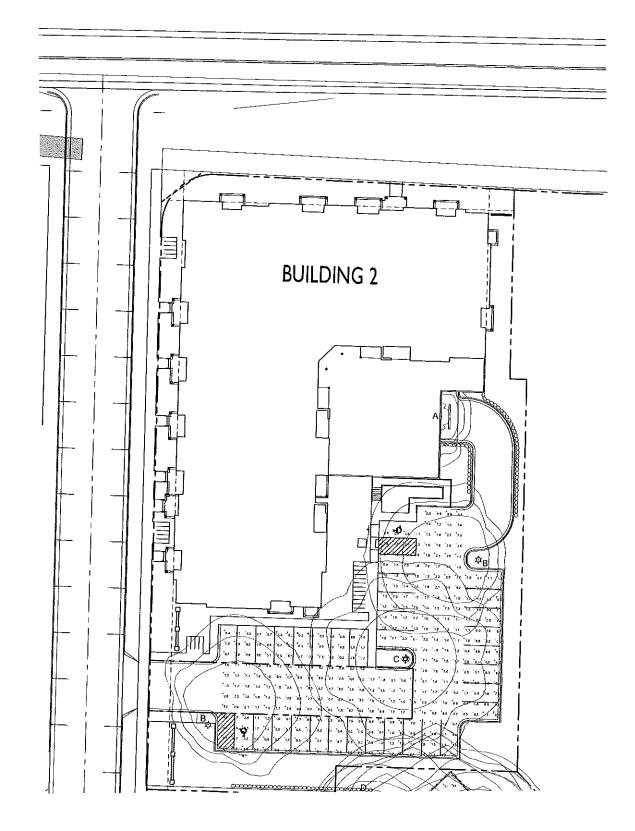



SSUED
Article 5 Submistati: January 15, 2015
Article 5 Re-Submittal: February 5, 2015


PROJECT TITLE
THE ADDISON **BUILDING 2**


NORTH PARK LANE & LACY ROAD SHEET TITLE SITE LIGHTING PLAN

SHEET NUMBER

1332 ⊗ Knathe & Bruce Architects, LLC

BUILDING #2 SITE LIGHTING PLAN

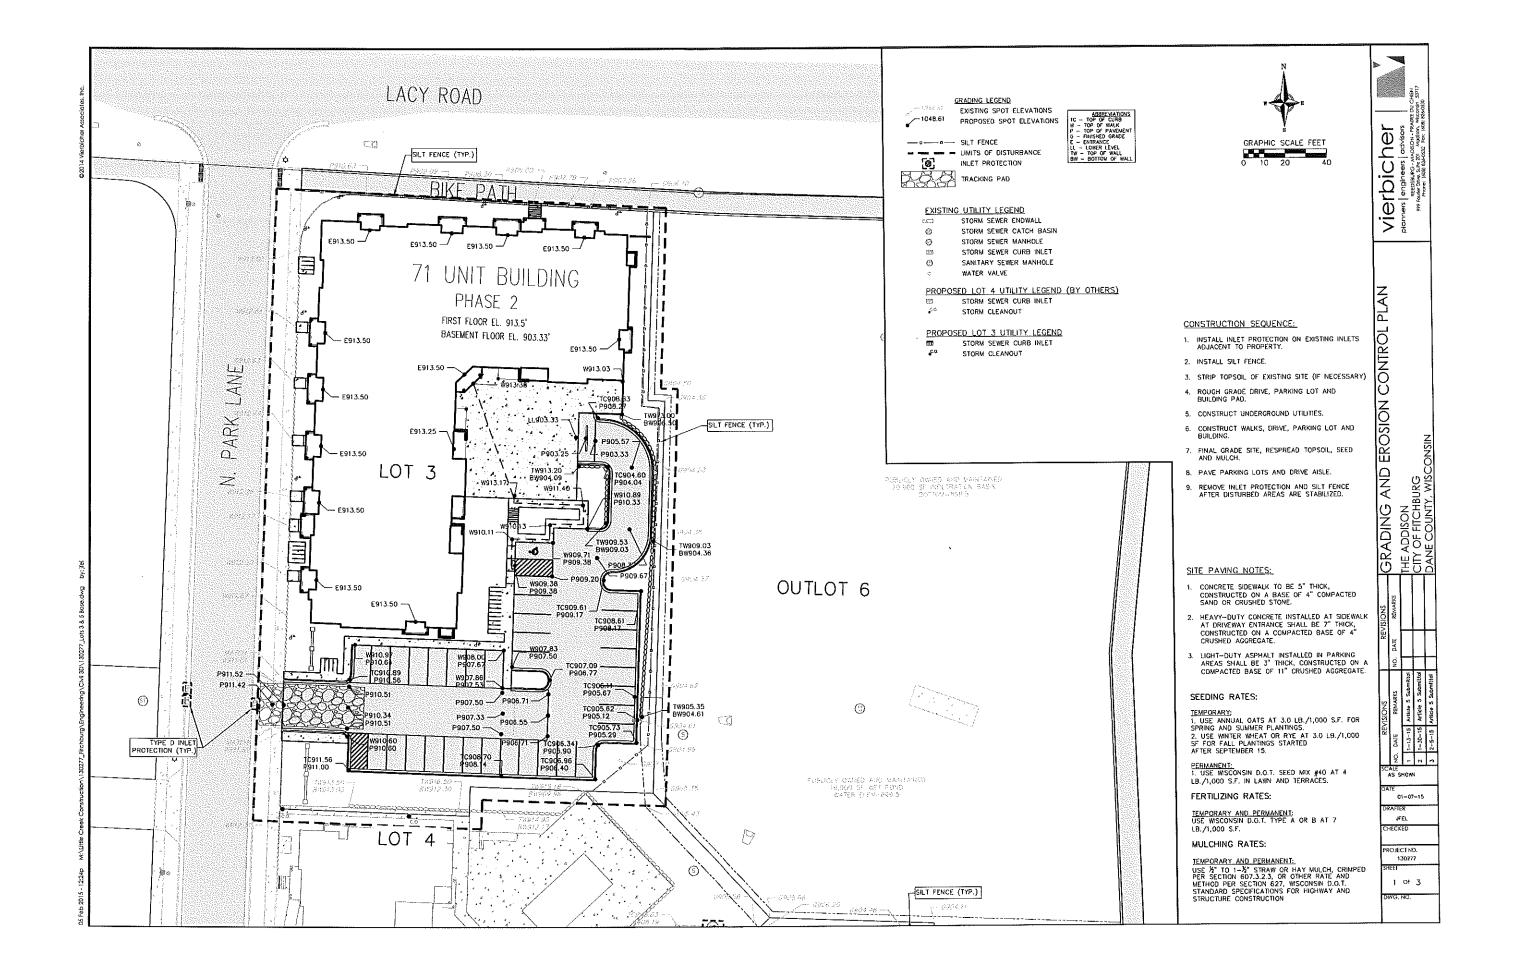

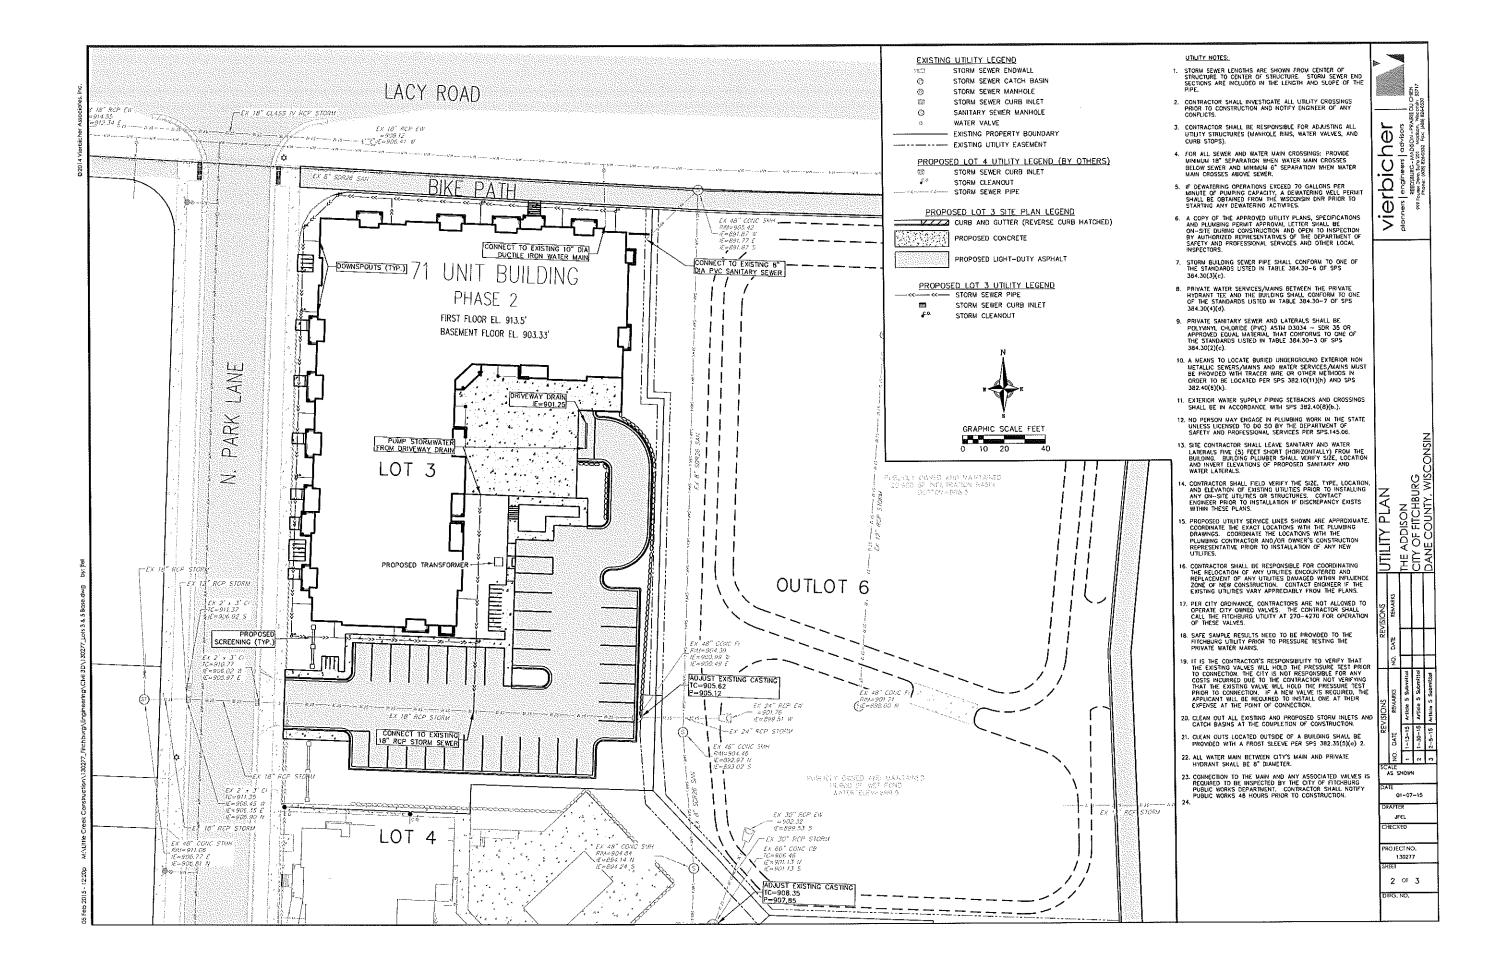

D' MINIMUM LENGTH


MINIMUM 12" OEEP


MOUNTABLE BERM 6" MIN. HEIGHT (OPTIONAL)

- EXISTING PAVEMENT

- EARTH FILL

- 1. FOLLOW WISCONSIN DNR TECHNICAL STANDARD 1057 FOR FURTHER DETAILS AND INSTALLATION.
- 3. WIDTH 24' MINIMUM, SHOULD BE FLARED AT THE EXISTING ROAD TO PROVIDE A TURNING RADIUS.
- 4. ON SITES WITH A HIGH GROUND WATER TABLE OR WHERE SATURATED CONDITIONS EXIST, GEOTEXTILE FABRIC SHALL BE PLACED OVER EXISTING GROUND PRIOR TO PLACING STONE, FABRIC SHALL BE WISDOT TYPE—HR GEOTEXTILE FABRIC.
- 5. STONE CRUSHED 3" CLEAR STONE SHALL BE PLACED AT LEAST 12" DEEP OVER THE ENTIRE LENGTH AND WIDTH OF ENTRANCE.
- 6. SURFACE WATER ALL SURFACE WATER FLOWING TO OR DIVERTED TOWARDS CONSTRUCTION ENTRANCES SHALL BE PIPED THROUGH THE ENTRANCE. MAINTAINING POSITIVE DRAMAGE. PIPE INSTALLED THROUGH THE STABILIZED CONSTRUCTION ENTRANCE SHALL BE PROTECTED WITH A MOUNTABLE BERN WITH 5:1 SLOPES AND MINIMUM OF 6" STONE OVER THE PIPE. PIPE SHALL BE SIZED ACCORDING TO THE DRAINAGE REQUIREMENTS. WHEN THE ENTRANCE IS LOCATED AT A HIGH SPOT AND HAS NO DRAINAGE TO CONVEY A PIPE SHALL NOT BE NECESSARY. THE MINIMUM PIPE DIAMETER SHALL BE 6". CONTRACTOR SHALL BE RESPONSIBLE FOR THE MAINTENANCE OF SAID PIPE.
- 7. LOCATION A STABILIZED CONSTRUCTION ENTRANCE SHALL BE LOCATED WHERE CONSTRUCTION TRAFFIC ENTERS ANO/OR LEAVES THE CONSTRUCTION SITE. VEHICLES LEAVING THE SITE MUST TRAVEL OVER THE ENTIRE LENGTH OF THE TRACKING PAD.

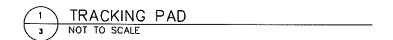

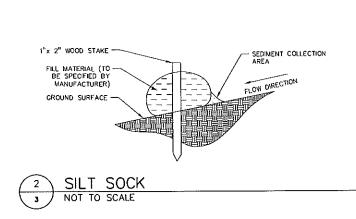

BAG TO BE CONSTRUCTED USING GEOTEXTILE FABRIC, WISDOT TYPE

DIMENSIONS OF TOP OPENING OF BAG TO MATCH INLET GRATE.

FRONT, BACK AND BOTTOM PANEL TO BE MADE FROM SINGLE PIECE OF FABRIC (NO SEAMS).

FLAP POCKET TO BE FITTED WITH REBAR OR STEEL ROD FOR REMOVAL. IF USED WITH CURB BOX, FLAP POCKETS TO BE FITTED WITH WOOD 2" x 4", EXTENDED 10" BEYOND GRATE WIDTH AND SECURED TO GRATE WITH TIES. THE WOOD SHALL NOT BLOCK THE ENTIRE HEIGHT OF THE CURB BOX OPENING.

TRIM EXCESS FABRIC IN THE FLOW LINE TO WITHIN 3" OF THE GRATE.

— 4" x 6" OVAL HOLE CUT INTO ALL FOUR SIDE PANELS. HOLES TO BE POSITIONED MIN. 8" BELOW INLET GRATE AND MIN. 12" ABOVE BOTTOM PANEL.

OOUBLE STITCHED SEAMS AROUND SIDE PANELS AND AT FLAP POCKETS.

- BOTTOM DIMENSION = 12"


INSTALLED BAO SHALL HAVE A MIN. SIDE CLEARANCE OF 3" FROM THE INLET WALLS, MEASURED AT THE HOLES, IF NECESSARY, CONTRACTOR SHALL CINCH THE BAG (MAX. FROM BAG BOTTOM) TO ACHIEVE

INLET PROTECTION DEVICES SHALL BE MAINTAINED OR REPLACED AT THE DIRECTION OF THE ENGINEER.

WHEN REMOVING OR MAINTAINING INLET PROTECTION, ANY TRAPPED MATERIAL THAT FALLS INTO THE INLET SHALL BE IMMEDIATELY REMOVED BY THE CONTRACTOR.

IF INLET DEPTH FROM TOP OF GRATE TO BOTTOM OF INLET IS LESS THAN 30", CONTRACTOR
SHALL SUBSTITUTE WISDOT TYPE C
INLET PROTECTION.

INLET PROTECTION TYPE D NOT TO SCALE

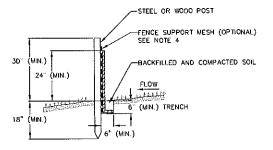

- 1. INSTALL SILT FENCE TO FOLLOW THE GROUND CONTOURS AS CLOSELY AS POSSIBLE.
- CURVE THE SILT FENCE UP THE SLOPE TO PREVENT WATER FROM RUNNING AROUND THE
- POST SPACING WITH FENCE SUPPORT MESH = 10 FT. (MAX.)
 - POST SPACING WITHOUT FENCE SUPPORT MESH = 6 FT. (MAX.)
- 4. SILT FENCE SUPPORT MESH CONSISTS OF 14-CAUGE STEEL WRE WITH A MESH SPACING OF 6 IN. X 6 IN. OP PREFABRICATED POLYMERIC MESH OF EQUIVALENT STRENGTH



VIERDICHET
planners | engineers | advisors
eggssugg. Avalago. Parkling
Progress Des and all washing and
Progress (68) gefeats the (68) gefeat

CONSTRUCTION DETAILS
NORTH PARK - PHASE 1 - LOT 4
CITY OF FITCHBURG
DANE COUNTY, WISCONSIN

3 OF 3

PO JECT NO 130277

AS SHOWN 06-05-14 JFEL HECKED



PLANTING NOTES!

PLANTING NOTES!

**CANTRACTOR SHALL VERRY LOCATION OF ALL ON-SHE UNDITES PINCK TO COMMENTE ANY WORK OF-SHE, WISTATE STATUTE 182.0175 REDUKES THREE WORK DATS NOTICE BEFORE YOU EXCAVATE. CALL DOORS IS HONGE AT 1-800-242-8511.

**SOUTHY AND NOTALL ALL WISCOMS ORGANINATION OF GOOK, GUARANTEE ALL STOCK FOR A PERIOD OF ON YEAR, ALL PLANTING MATERIAL DI TO MEET AMERICAN STATEMADES FOR NAMERY STOCK AND STATEMATION AND INCIDENCE OF STATEMATICAL AND INCIDENCE ON SILE. PLANTITY THE ABRINA AND INCIDENCE ON SILE. PLANTITY THE SHALL HAVE PERSONNED PLANTITY OF SILES, AND CHARTING ARE ACCORDING ON SILE. PLANTITY OF SILES, AND CHARTING PLANTIL COURS AND ORGANIC DESCRIPTIONS, CRAPHOLITY DEPOTED DIAMITIES SHALL HOLD PRECIDENCE.

**3)ACTUAL LOCATIONS OF PLANTI MATERIAL ARE SUBJECT TO FINAL SHE LAYOUT AND CONCINCION AND MAY BE ARRUSTED ACCORDINGLY.

DIACTUAL LOCATIONS OF PLANT MATERIAL ARE SUBJECT TO FINAL SITE LAYOUT AND CONCITIONS AND MAY BE ADJUSTED ACCORDINGLY.

AGUY AND STATE ALL LARGE TRIFTS AND EVENSIFIEMS.

DIALI PLANTS ARE TO BE BACKFLIED WITH A 50/50 MX OF PLANT STAKTER MULTGESOL BLIND AND IS TO BE FREE OF KOOTS, ROCKS LARGER THAN 1"IN TIMESTER, SUBSOL REBRIS, AND WEEDS.

GOOTEN AND REMOVE THE TOP BURLAP AND TIMES OR STRING FROM ALL BAILLED AND BURLAPHING AND SET ALL PLANTS AT FESSHED GRADS.

TO SHELP HOT PLANTS AND SET ALL PLANTS AT FESSHED GRADS.

TO SHELP AND PESTAL 3"A" OF SHREEDOO HARCHINGO BACK MAIGH IN ALL PLANTING BEDS, AND 1-11/2"


IN ALL FERSINAL BEDS. THE AT ALL AREAS WITH A PRE-THERGENT HERBODE (GRANALAR FORM) "TREILAN" OR APPROVED COURT FOLLOWING ALL MANAFACTURER'S WRITTEN INSTALLARIEN INSTITUCTIONS PROFT TO PLACING MAIGH.


BOUPLY AND NOTALL 3-4" OF SPRECTED HARDWOOD MUCH I PAST THE GRP LIVE OF ALL NOWCUM.
TREES. DO NOT PLACE MUCH AGAINST TRUX OF TREE.
95-UPPLY AND INSTALL BLACK VIVIL EGING "AGE OF DIAMORD" MANUTACTURED BY VALLETYEW DOUSTRES

OR APPROVED EQUAL IN ALL PLANTING BEDS THAT ADJON TURE AREAS ACCORDING TO THE MANUFACTURER'S


VERTICAL BASTALLATION DOTECTIONS.

10 AL TURE AREAS ARE TO BE FIRE-GRADED. ALL TURE AREAS ARE TO BE SELECT, AREAS ARE TO BE SONIN AT THE MANUFACTURER'S RECOMMETCED PARTERS AND COVERED WITH A CERT MAY ARE ARE TO BE SOME AT THE MANUFACTURER'S RECOMMETCED PARTERS AND COVERED WITH A CERT MAY FOR THE PECCAMENCE PARTER, A STARTER RETUZER APPLED, AND COVERED WITH A CLEMINOST STEAM, ANY AREAS WHERE POTENTIAL RECOMMEDSTS ARE TO WIN ON WATER OR OTHER NEADS MOLLOWS ALL SLOTES OF \$31 CR GREATER SHALL BE COVERED WITH STANWERSOM CONTROL BLANKETS DO 7575 MANUFACTURED BY NORTH AMERICAN GREAT INSTITUTIONS.

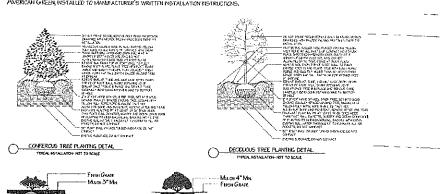

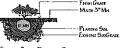



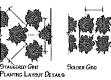

Residential






Миаг4" Мы

TREE & SHRUB SLOPE PLANTING DETAIL

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Sheet Title:

LANDSCAPE PLAN

Project

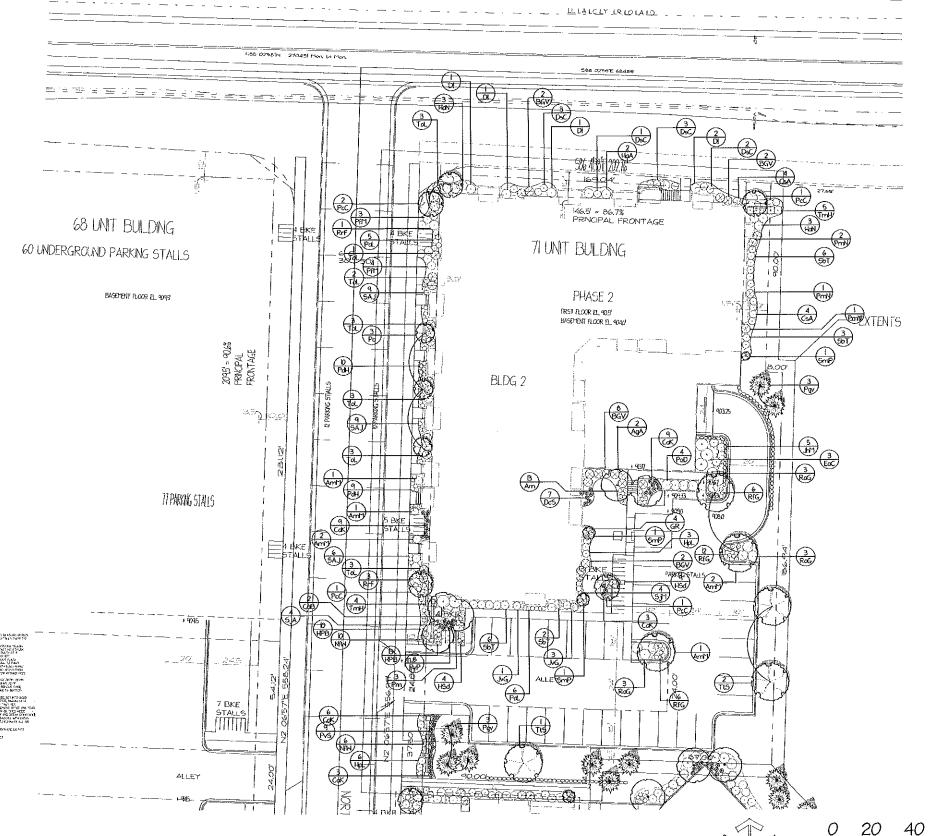ARTICLE 5 SUBMITTAL:

THE ADDISON FITCHBURG. WI

Plan Notes:

Designed By: C. J. N. Drawn By: C. J. N. Date: 1-13-15 Rovisions: 1-30-15

Notice:

N


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This plan is subject to final on-site conditions and may be modified to account for unforseen obstacles, other changes, or site modifications that were not made







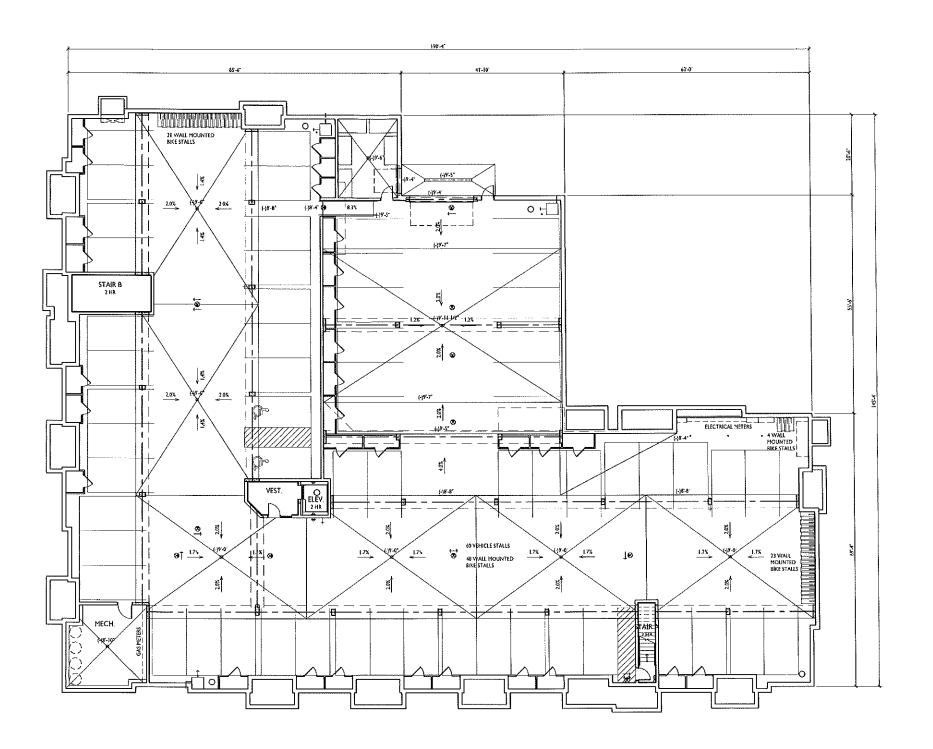

ISSUED Article 5 Submittal: January 15, 2015

PROJECT TITLE
FEDLER SYENE RD
PHASE 2
BUILDING 2

NORTH PARK TRAIL & LACY ROAD SHEET TITLE Basement Floor Plan

SHEET NUMBER

A-1.0

PROJECT NO. 1332









ISSUED

Article 5 Submittal: January 15, 2015 Article 5 Re-Submittal: Eebruary 5, 2015



19 % 11%

38 %

COMPOSITE TRIM & PANEL

BRICK VENEER / CAST STONE



NORTH ELEVATION

2 NUKITE A-2.1 SCALE: 1/8 =1.0

PROJECT TITLE THE ADDISON **BUILDING 2**

NORTH PARK LANE & LACY ROAD SHEET TITLE **EXTERIOR ELEVATIONS**

SHEET NUMBER

PROJECT NO. 1332 S Knothe & Bruce Architects, ELC

EXIER	IOR MATERIAL	SCHEDULE
BUILDING MATERIAL	MATERIAL	COLOR
KOOF	ASPHALT SPRIGLES	OWENE CORNENG PRO 30: DRETWOOD
NOOF FLASHENG	ALLEGAM	TEO - VENEY WI ARCHITECT
HONZONTAL YANYL BOANG - (I)	ABAAT	CERTAINTEED HONOGRAH 46: SUIDE
HONIZONTAL VINYL EDING - (1)	AMAL	CERTAINTEED HONOGRAM 44: SAMLE MADWN
COHPOSITE TRUM AND PANELS	COMPOSITE	SW 7331 "CANVAS TANF
ALLIHANUM FASGA	ALHRAM	HASTIC "ALMOND"
MAKK VENEER	HABONAY	BORAL - ALLENDALE HELL KING SIZE
HORTAR COLOR @ BRICK VENEER	HARONAY	QUIKAETE "WHEAT"
SEALANT (I BINCK YENER	T.B.D.	THE (MATCH INUCK) - SUSHIT TO ANCHITECT
METAL RASISHIG & MAICK VENEER	GALV. STEEL	FACICIAD "MANSAID BADWIN"
CAST STONE SELIS & HISADS	CAST STONE	EXWARDS CAST STONE: II-018
HETAL RASING & MECAST	GALV. STEEL	INC CIVE ATHONE.
WINDOWS	ANAT	TAN
EALANT & WINDOWS	TAD,	TO HATCH WINDOWS
RALING	AUPRAPA	DARK BRONZE
DECK BOAADS	TREATED WOOD	ТВО
DECK SKRT	COMPOSITE	SW 7331 "CANYAS YAN"
FLASHING & DECK EDGE	GALV. STEEL	LVC CIVD ,VTMOMO,
FLASHING (\$ DECX LEDGE).	GALV. STEEL	HATCH ADJACENT SIDENG/HASONSKY
ENTRY DOORS	INSULATED METAL	DARK BRONZE
GATAGE HAN DOOR	ANNA TED HETAL	SW 7531 "CANVAS TAN"
OYEKHEAD GARAGE DOOR	ALLMENUM	CHT VIHONO
SWINGING UNIT PATIO DOORS	PERCIAS	STAINED - TRO BY ARCHITECT


MAKEN VENERR / CAST STONE





ISSUED Article 5 Submitted: January 15, 2015 Article 5 Re-Submitted: February 5, 2015

ļi	BUILDING MATERIAL	%
The state of the s	DOOM / WINDOWS	25 %
Ţ	VINYL SIDING	24%
	COMPORTE TRIM & PANEL	9%
	MAJCK YENTER / CAST STONE	42%
A-12 SCALE 1/8"=1"0"		

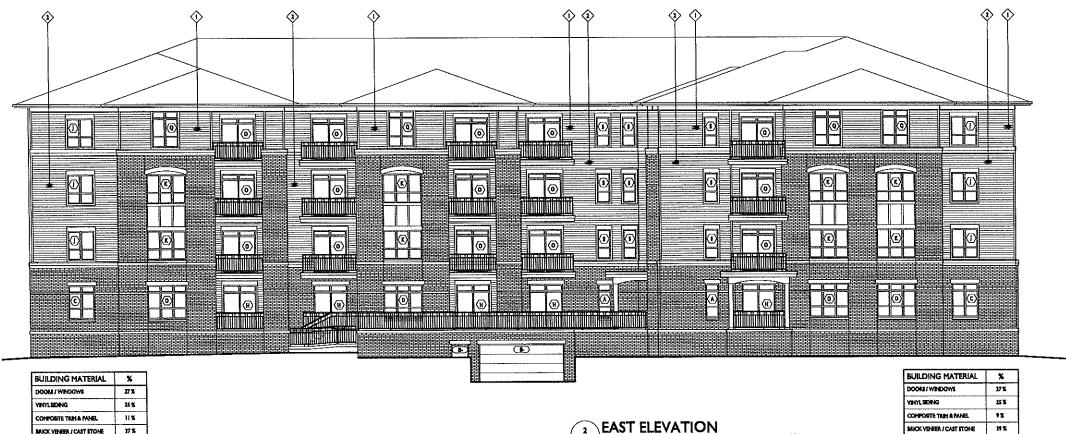

27%

25 %


9%

39 %

DOOM / WINDOWS

BUCK YENEER / CAST STONE

VINYL BOXNG COMPOSITE THAN & MANEL

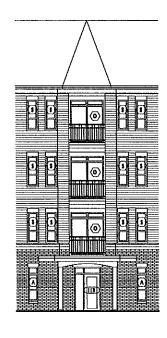

PROJECT TITLE THE ADDISON **BUILDING 2**

NORTH PARK LANE & LACY ROAD SHEET TITLE **EXTERIOR ELEVATIONS**

BUILDING MATERIAL BREAKDOWN IS COMBINED WITH EAST ELEVATION SHEET NUMBER

A-2.2

PROJECT NO. 1332

HIDDEN ELEVATION
A-2.2 SCALE 1/8"=1'-0"

BUCK VENEER / CAST STONE 39%